

UNITED STATES
DEPARTMENT OF THE INTERIOR
BUREAU OF LAND MANAGEMENT

APPLICATION FOR PERMIT TO DRILL OR REENTER



FORM APPROVED
OMB No. 1004-0137
Expires March 31, 2007

1a. Type of work: <input checked="" type="checkbox"/> DRILL <input type="checkbox"/> REENTER		5. Lease Serial No. UTU 61400	
1b. Type of Well: <input type="checkbox"/> Oil Well <input checked="" type="checkbox"/> Gas Well <input type="checkbox"/> Other <input type="checkbox"/> Single Zone <input checked="" type="checkbox"/> Multiple Zone		6. If Indian, Allottee or Tribe Name	
2. Name of Operator EOG RESOURCES, INC		7. If Unit or CA Agreement, Name and No.	
3a. Address 1060 EAST HIGHWAY 40 VERNAL, UT 84078		8. Lease Name and Well No. HOSS 32-30	
3b. Phone No. (include area code) 435-781-9111		9. API Well No. 43-047-38701	
4. Location of Well (Report location clearly and in accordance with any State requirements.)* At surface 2050 FSL 480 FWL NWSW 40.082106 LAT 109.377192 LON At proposed prod. zone SAME 4439.035 Y 40.092128 -109.376510		10. Field and Pool, or Exploratory NATURAL BUTTES	
14. Distance in miles and direction from nearest town or post office* 39.3 MILES SOUTH OF VERNAL, UTAH		11. Sec., T. R. M. or Blk. and Survey or Area SECTION 30, T8S, R23E S.L.B.&M	
15. Distance from proposed* location to nearest property or lease line, ft. (Also to nearest drig. unit line, if any) 480 LEASE LINE 480 DRILLING LINE		12. County or Parish UINTAH	
16. No. of acres in lease 628		13. State UT	
17. Spacing Unit dedicated to this well 37			
18. Distance from proposed location* to nearest well, drilling, completed, applied for, on this lease, ft. 6200		20. BLM/BIA Bond No. on file NM 2308	
19. Proposed Depth 10,035		21. Estimated duration 45 DAYS	
22. Elevations (Show whether DF, KDB, RT, GL, etc.) 4886 GL			

24. Attachments

The following, completed in accordance with the requirements of Onshore Oil and Gas Order No.1, must be attached to this form:

- Well plat certified by a registered surveyor.
- A Drilling Plan.
- A Surface Use Plan (if the location is on National Forest System Lands, the SUPO must be filed with the appropriate Forest Service Office).
- Bond to cover the operations unless covered by an existing bond on file (see Item 20 above).
- Operator certification
- Such other site specific information and/or plans as may be required by the BLM.

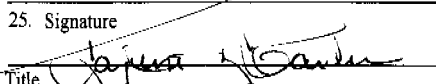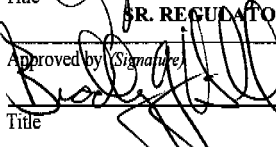25. Signature 	Name (Printed Typed) KAYLENE R. GARDNER	Date 10/02/2006
Title SR. REGULATORY ASSISTANT		
Approved by (Signature) 	Name (Printed Typed) BRADLEY G. HILL	Date 10-26-06
Title OFFICE ENVIRONMENTAL MANAGER		

Application approval does not warrant or certify that the applicant holds legal or equitable title to those rights in the subject lease which would entitle the applicant to conduct operations thereon.
Conditions of approval, if any, are attached.

Title 18 U.S.C. Section 1001 and Title 43 U.S.C. Section 1212, make it a crime for any person knowingly and willfully to make to any department or agency of the United States any false, fictitious or fraudulent statements or representations as to any matter within its jurisdiction.

*(Instructions on page 2)

Federal Approval of this
Action is Necessary

RECEIVED

OCT 10 2006

DIV. OF OIL, GAS & MIN.

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T8S, R23E, S.L.B.&M.

EOG RESOURCES, INC.


Well location, HOSS #32-30, located as shown in Lot 3 of Section 30, T8S, R23E, S.L.B.&M., Uintah County, Utah.

BASIS OF ELEVATION


BENCH MARK 20EAM LOCATED IN THE SE 1/4 OF SECTION 35, T8S, R21E, S.L.B.&M. TAKEN FROM THE OURAY SE, QUADRANGLE, UTAH, UINTAH COUNTY, 7.5 MINUTE QUAD. (TOPOGRAPHIC MAP) PUBLISHED BY THE UNITED STATES DEPARTMENT OF THE INTERIOR, GEOLOGICAL SURVEY. SAID ELEVATION IS MARKED AS BEING 4697 FEET.

BASIS OF BEARINGS


BASIS OF BEARINGS IS A G.P.S. OBSERVATION.

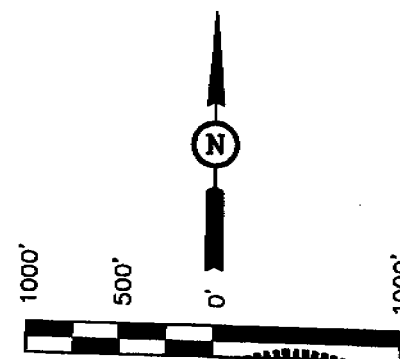

THIS IS TO CERTIFY THAT THE ABOVE PLAT WAS PREPARED FROM FIELD NOTES OF ACTUAL SURVEY OR UNDER MY SUPERVISION AND THAT THE SAME ARE TRUE AND CORRECT TO THE BEST OF MY KNOWLEDGE AND BELIEF.

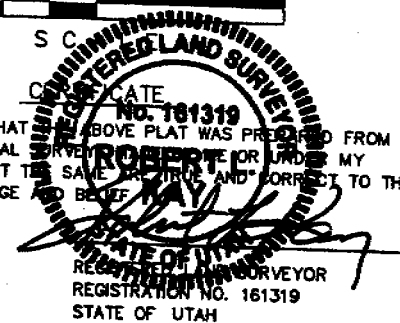

R
23
E

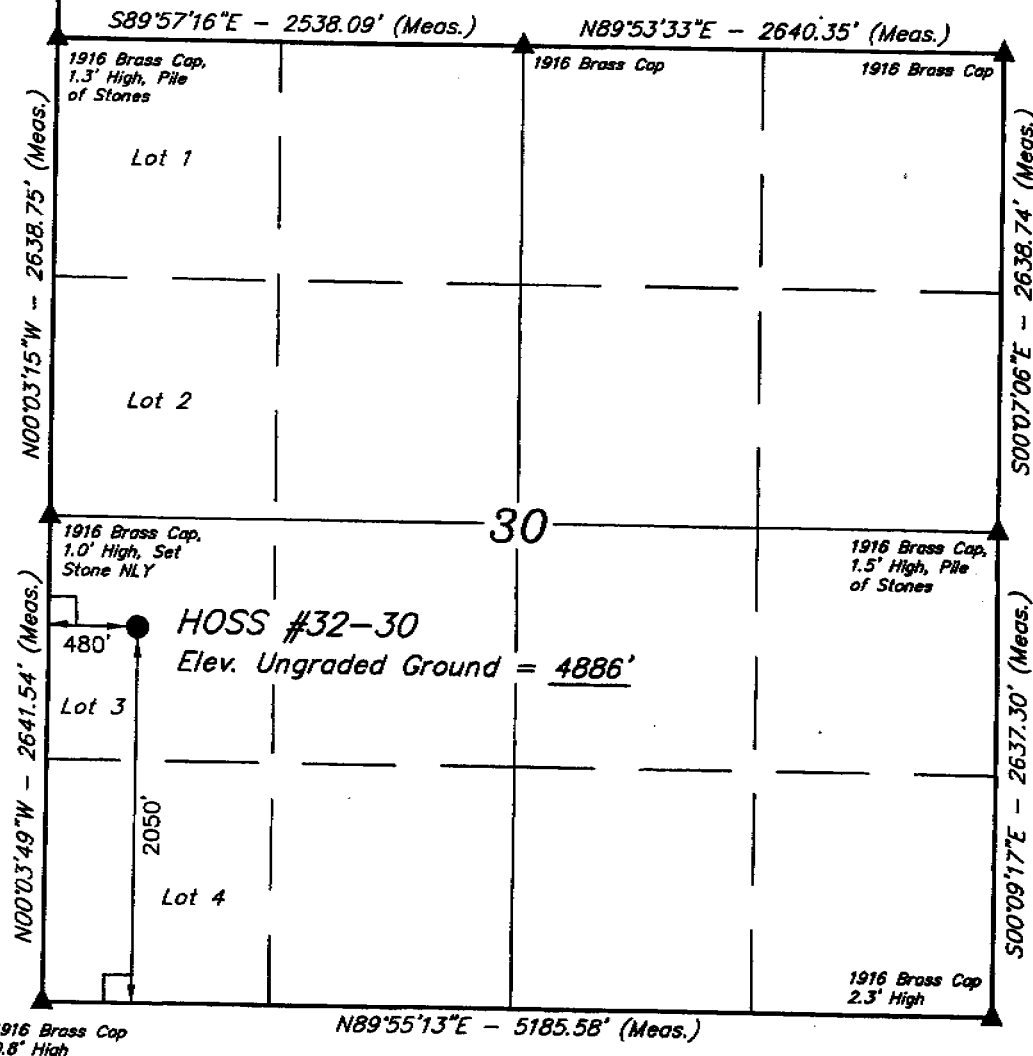

LEGEND:

- └─┘ = 90° SYMBOL
- = PROPOSED WELL HEAD.
- ▲ = SECTION CORNERS LOCATED.

(NAD 83)
 LATITUDE = 40°05'31.58" (40.082106)
 LONGITUDE = 109°22'37.89" (109.377192)
 (NAD 27)
 LATITUDE = 40°05'31.71" (40.092142)
 LONGITUDE = 109°22'35.43" (109.376508)

UINTAH ENGINEERING & LAND SURVEYING
 85 SOUTH 200 EAST - VERNAL, UTAH 84078
 (435) 789-1017

SCALE 1" = 1000'	DATE SURVEYED: 07-05-06	DATE DRAWN: 07-07-06
PARTY T.A. B.C. C.G.	REFERENCES G.L.O. PLAT	
WEATHER WARM	FILE EOG RESOURCES, INC.	

STATE OF UTAH)

) ss

COUNTY OF UTAH)

VERIFICATION

Kaylene R. Gardner, of lawful age, being first duly sworn upon oath, deposes and says:

She is the Sr. Regulatory Assistant of EOG Resources, Inc., of Vernal, Utah. EOG Resources, Inc. is the operator of the following described well:

HOSS 32-30
2050' FSL – 480' FWL NWSW (LOT 3)
SECTION 30, T8S, R23E
UINTAH COUNTY, UTAH

EOG Resources, Inc., EnCana Oil & Gas (USA) Inc, Questar Exploration and Production Company, and Newfield Production Company, Exhibit A, are the only owners in the well and/or of all contiguous oil and gas leases or drilling units overlying the pool.


On the 6th day of October 2006 she placed in the United States mail, with postage prepaid, a copy of the attached Application for Commingling in one wellbore for the subject well.

Said envelope which contained these instruments was addressed to the Utah Division of Oil, Gas & Mining, Bureau of Land Management, EnCana Oil & Gas (USA) Inc, Questar Exploration and Production Company, and Newfield Production.

Further affiant saith not.


Kaylene R. Gardner
Sr. Regulatory Assistant

Subscribed and sworn before me this 6th day of October, 2006.

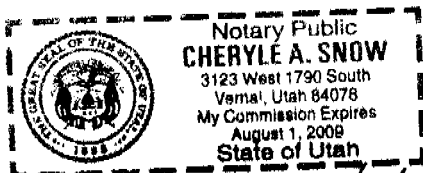

My Commission Expires: 8/1/2009

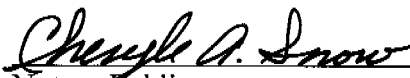

Cheryle A. Snow
Notary Public

Exhibit "A" to Affidavit
Hoss 32-30 Application to Commingle


Encana Oil & Gas (USA) Inc.
950 17th Street, Suite 2600
Denver, Colorado 80202
Attn: Mr. Doug Jones

Questar Exploration and Production Company
Independence Plaza
1050 17th Street, Suite 500
Denver, Colorado 80265
Attention: Ms. Angela Page

Newfield Production Company
1401 17th Street, Suite 1000
Denver, CO 80202
Attn: Gary Alsobrook

R 22 E

R 23 E

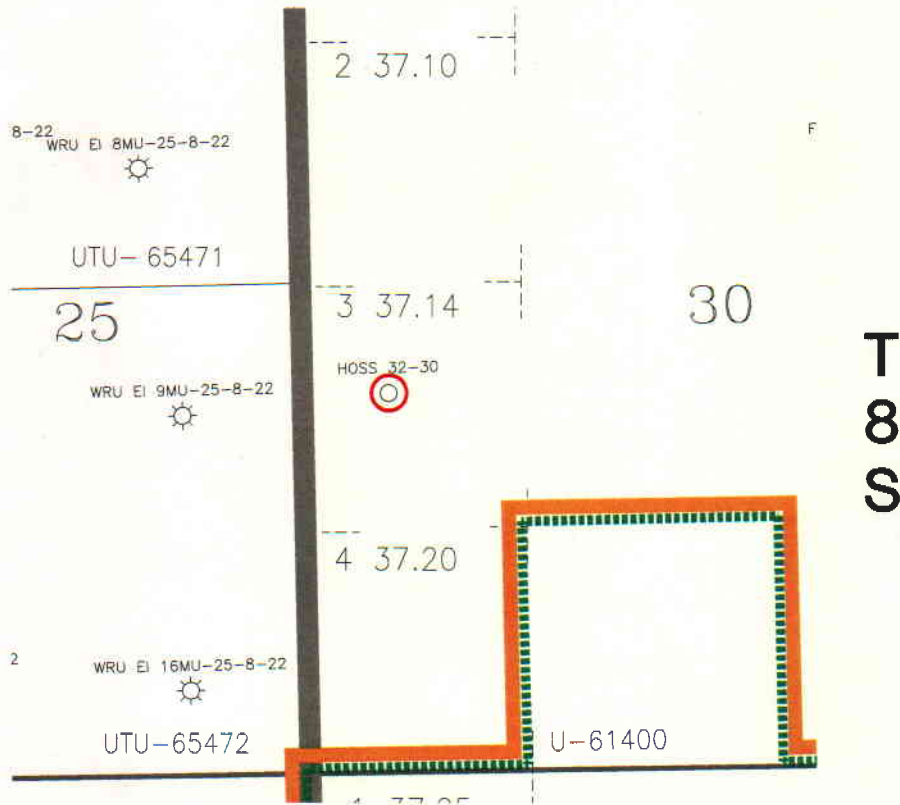

○ HOSS 32-30

— Badlands Unit Outline

----- Wasatch/Mesaverde/Mancos Fms P.A. "B"

Scale: 1"=1000'
0 1/4 1/2 Mile



Denver Division

EXHIBIT "A"

HOSS 32-30
Commingling Application
Utah County, Utah

Scale:
1"=1000'

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Author
GT

Sep 14, 2006 -
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EIGHT POINT PLAN

HOSS 32-30

NW/SW, SEC. 30, T8S, R23E, S.L.B.&M..

UINTAH COUNTY, UTAH

1. & 2. ESTIMATED TOPS & ANTICIPATED OIL, GAS, & WATER ZONES:

FORMATION	DEPTH (KB)
Green River FM	2,234'
Wasatch	5,243'
Chapita Wells	5,909'
Buck Canyon	6,579'
North Horn	7,203'
KMV Price River	7,771'
KMV Price River Middle	8,582'
KMV Price River Lower	9,436'
Sego	9,825'

Estimated TD: **10,035' or 200'± below Sego top**

Anticipated BHP: 5,480 Psig

1. Fresh Waters may exist in the upper, approximately 1,000 ft ± of the Green River Formation, with top at about 2,000 ft ±.
2. Cement isolation is installed to surface of the well isolating all zones by cement.

EOG Resources, Inc. requests authorization for commingling of production from the Wasatch and Mesaverde formations in the referenced wellbore. In the event allocation of production is necessary, the allocation will be based on proportionate net pay as calculated from open hole logs. Production from the Wasatch and Mesaverde formations will be commingled in the wellbore and produced through open ended 2-3/8" tubing landed below all perforations in the 4-1/2: production casing.

Attached is a map showing the location of all wells on contiguous oil and gas leases or drilling units and an affidavit showing that this application has been provided to owners of all contiguous oil and gas leases or drilling units overlying the pool.

3. PRESSURE CONTROL EQUIPMENT:

Production Hole – 5000 Psig
BOP schematic diagrams attached.

4. CASING PROGRAM:

	<u>HOLE SIZE</u>	<u>INTERVAL</u>	<u>SIZE</u>	<u>WEIGHT</u>	<u>GRADE</u>	<u>THREAD</u>	<u>RATING FACTOR</u>		
							<u>COLLAPSE</u>	<u>BURST</u>	<u>TENSILE</u>
Conductor:	17 1/2"	0' – 45'	13 3/8"	48.0#	H-40	STC	770 PSI	1730 PSI	322,000#
Surface	12-1/4"	45' – 2,300'KB±	9-5/8"	36.0#	J-55	STC	2020 PSI	3520 Psi	394,000#
Production:	7-7/8"	2,300'± – TD	4-1/2"	11.6#	P-110	LTC	7560 PSI	10,710 Psi	284,000#

EIGHT POINT PLAN

HOSS 32-30

NW/SW, SEC. 30, T8S, R23E, S.L.B.&M.,
UINTAH COUNTY, UTAH

Note: 12-1/4" surface hole will be drilled to a total depth of 200'± below the base of the Green River lost circulation zone and cased w/9-5/8" as shown to that depth. Drilled depth may be shallower or deeper than the 2300' shown above depending on the actual depth of the loss zone. **All casing will be new or inspected.**

5. Float Equipment:

Surface Hole Procedure (0' - 2300'±)

Guide Shoe

Insert Float Collar (PDC drillable)

Centralizers: 1-5' above shoe, top of jts. #2 and #3 then every 5th joint to surface. (15 total)

Float Equipment: (Cont'd)

Production Hole Procedure (2300'± - TD):

Float shoe, 1 joint casing, float collar and balance of casing to surface. 4-1/2", 11.6#, N-80 or equivalent marker collars or short casing joints to be placed at top of Price River and 400' above top of Wasatch. Centralizers to be placed 5' above shoe on joint #1, top of joint #2, and every 2nd joint to 400' above Wasatch Island top. Thread lock float shoe, top and bottom of float collar, and top of 2nd joint.

6. MUD PROGRAM

Surface Hole Procedure (Surface - 2300'±):

Air/air mist or aerated water.

Production Hole Procedure (2300'± - TD): Anticipated mud weight 9.5 – 10.5 ppg depending on actual wellbore conditions encountered while drilling.

2300'± - TD A closed mud system will be utilized. A bentonite gelled water mud system will be used to control viscosity w/PHPA polymer used for supplemental viscosity and clay encapsulation/inhibition. Water loss will be maintained at <15cc's using white starch or PAC. Bactericides will be used as needed. Anticipated pH will range from 9.0-10.0. Mud weight will be adjusted as necessary for well control. Deflocculants/thinners will be used as necessary to maintain mud quality. LCM sweeps will be utilized as necessary to control lost circulation and mud loss. CO2 contamination, if encountered, will be treated with lime and gypsum.

EIGHT POINT PLAN

HOSS 32-30

NW/SW, SEC. 30, T8S, R23E, S.L.B.&M..
UINTAH COUNTY, UTAH

7. VARIANCE REQUESTS:

Reference: Onshore Oil and Gas Order No. 2 – Item E: Special Drilling Operations

EOG Resources, Inc. requests a variance to regulations requiring the blooie line to be 100' in length. Due to reduce location excavation, the blooie line will be approximately 75' in length

8. EVALUATION PROGRAM:

Logs: Mud log from base of surface casing to TD.

Cased-hole Logs: Cased-hole logs will be run in lieu of open-hole logs consisting of the following:
Cement Bond / Casing Collar Locator and Pulsed Neutron

9. CEMENT PROGRAM:

Surface Hole Procedure (Surface - 2300'±):

Lead: Class "G" cement with 16% Gel, 10 #/sx Gilsonite, 3% Salt, 2% CaCl₂, 3 lb/sx GR3 ¼ #/sx Flocele mixed at 11 ppg, 3.82 ft³/sk. yield, 23 gps water.

Tail: Class "G" cement with 2% CaCl₂, ¼#/sk Flocele mixed at 15.6 ppg, 1.18 ft³/sk., 5.2 gps water.

Top Out: As necessary with Class "G" cement with 2% CaCl₂, ¼#/sk Flocele mixed at 15.6 ppg, 1.18 ft³/sk., 5.2 gps water.

Note: Cement volumes will be calculated to bring lead cement to surface and tail cement to 500' above the casing shoe.

Production Hole Procedure (2300'± - TD)

Lead: 170 sks: Hi-Lift "G" w/12% D20 (Bentonite), 1% D79 (Extender), 5% D44 (Salt), 0.2% D46 (Antifoam), 0.25% D112 (Fluid Loss Additive), 0.25 pps D29 (cello flakes) mixed at 11.0 ppg, 3.91 ft³/sk., 24.5 gps water.

Tail: 930 sks: 50:50 Poz "G" w/ 2% D20 (Bentonite), 0.1% D46 (Antifoam), 0.075% D13 (Retarder), 0.2% D167 (Fluid Loss Additive), 0.2% D65 (Dispersant), mixed at 14.1 ppg, 1.28 ft³/sk., 5.9gps water.

EIGHT POINT PLAN

HOSS 32-30

NW/SW, SEC. 30, T8S, R23E, S.L.B.&M..
UINTAH COUNTY, UTAH

Note: The above number of sacks is based on gauge-hole calculation.
Lead volume to be calculated to bring cement to 200'± above 9-5/8" casing shoe.
Tail volume to be calculated to bring cement to 400'± above top of Wasatch.
Final Cement volumes will be based upon gauge-hole plus 45% excess.

10. ABNORMAL CONDITIONS:

Surface Hole (Surface - 2300'±):

Lost circulation

Production Hole (2300'± - TD):

Sloughing shales, lost circulation and key seat development are possible in the Wasatch Formation.

11. STANDARD REQUIRED EQUIPMENT:

- A. Choke Manifold
- B. Upper and Lower Kelly Cock
- C. Stabbing Valve
- D. Visual Mud Monitoring


12. HAZARDOUS CHEMICALS:

No chemicals subject to reporting under SARA title III in an amount equal to or greater than 10,000 pounds will be used, produced, stored, transported, or disposed of annually in association with the drilling of this well. Furthermore, no extremely hazardous substances, as defined in 40 CFR 355, in threshold planning quantities, will be used, produced, stored, transported, or disposed of in association with the drilling of this well.

(Attachment: BOP Schematic Diagram)


**EOG RESOURCES 11" 5,000 PSI W.P. BOP
CONFIGURATION**

PAGE 1 OF 2

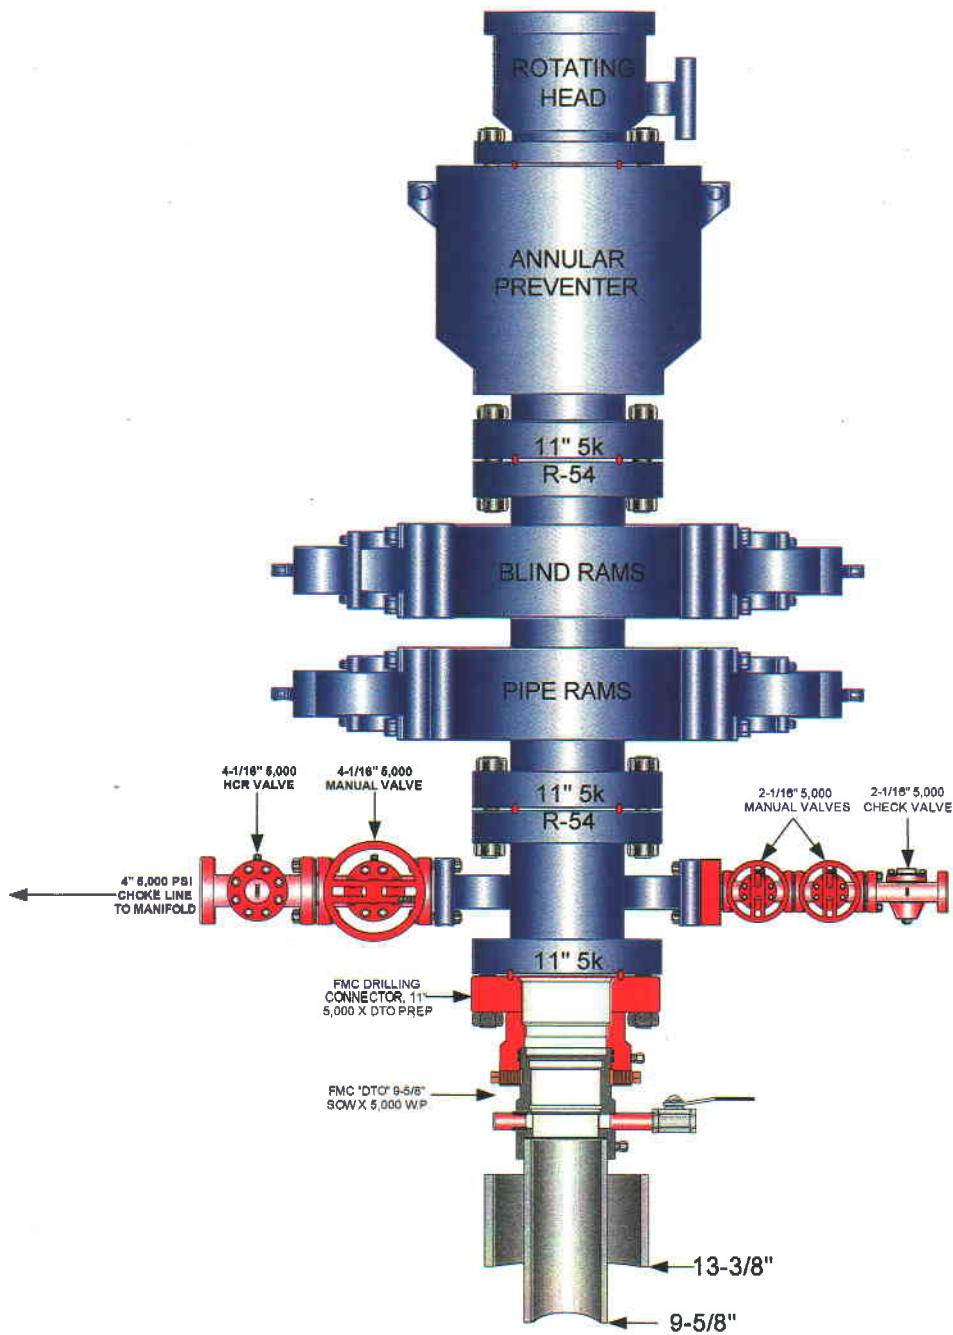

EOG RESOURCES CHOKE MANIFOLD CONFIGURATION W/ 5,000 PSI WP VALVES

PAGE 2 OF

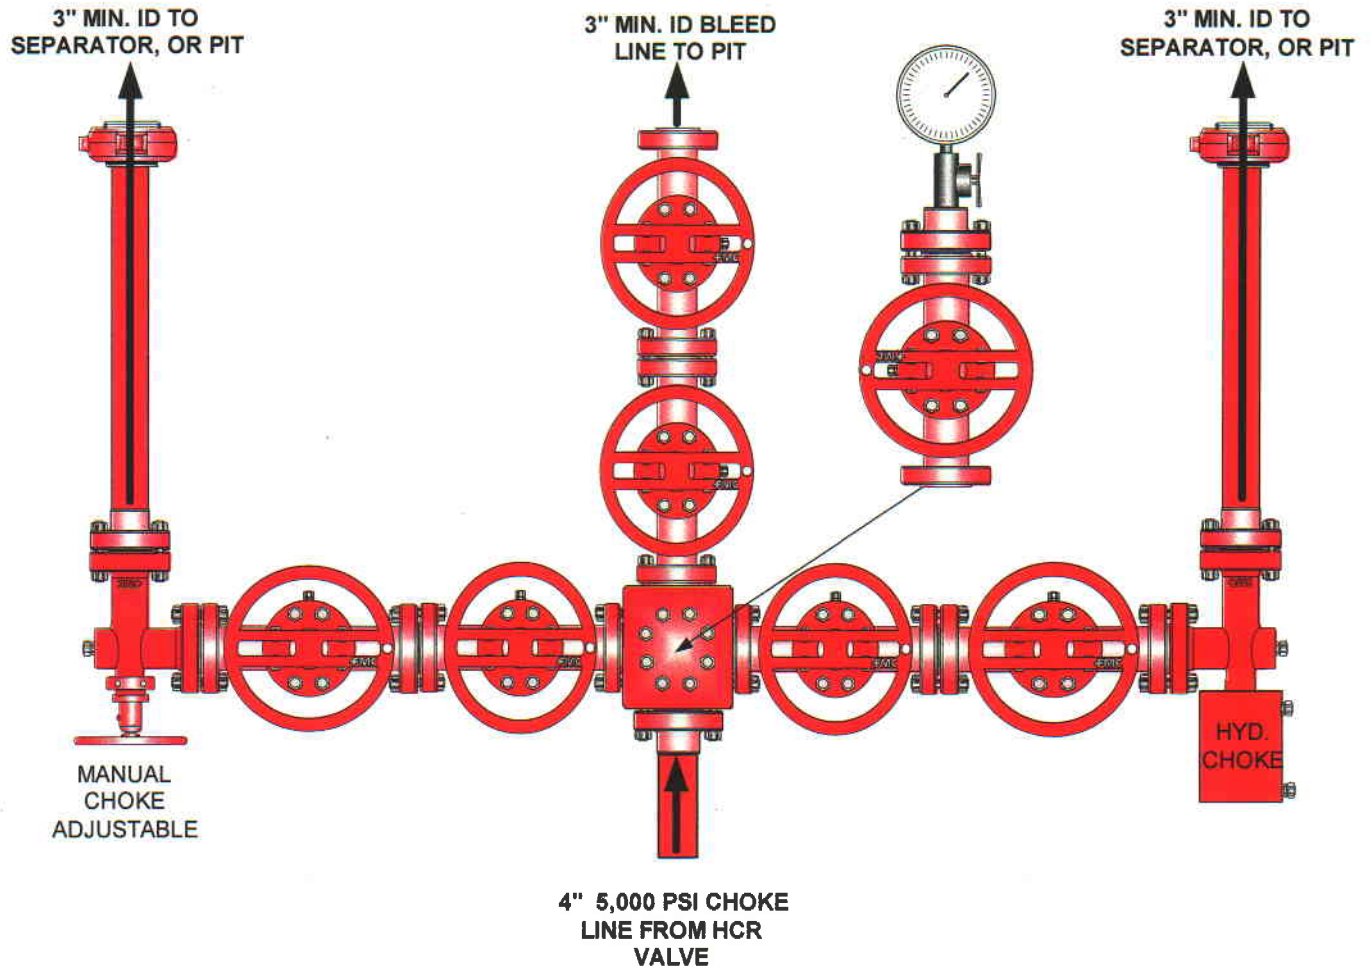

Testing Procedure:

1. BOP will be tested with a professional tester to conform to Onshore Order #2.
2. Blind and Pipe rams will be tested to rated working pressure, 5,000 psi.
3. Annular Preventer will be tested to 50% working pressure, 2,500 psi.
Casing will be tested to 0.22 psi / ft. or 1,500 psi. Not to exceed 70% of burst strength, **whichever is greater.**
4. All lines subject to well pressure will be tested to the same pressure as blind and pipe rams.
5. All BOPE specifications and configurations will meet Onshore Order #2 requirements.



**HOSS 32-30
NWSW, Section 30, T8S, R23E
Uintah County, Utah**

SURFACE USE PLAN

NOTIFICATION REQUIREMENTS

- Location Construction: Forty-eight (48) hours prior to construction of location and access roads.
- Location Completion: Prior to moving on the drilling rig.
- Spud Notice: At least twenty-four (24) hours prior to spudding the well.
- Casing String and Cementing: Twenty-four (24) hours prior to running casing and cementing all casing strings.
- BOP and related Equipment Tests: Twenty-four (24) hours prior to running casing and tests.
- First Production Notice: Within five (5) business days after new well begins or production resumes after well has been off production for more than ninety (90) days.

The well pad is approximately 325 feet long with a 246-foot width, containing 1.84 acres more or less. The well access road is approximately 1584 feet long with a 30-foot right-of-way, disturbing approximately 1.09 acres. New surface disturbance associated with access road and the well pad is estimated to be approximately 2.93 acres. The pipeline is approximately 1860 feet long with a 40-foot right-of-way, disturbing approximately 1.71 acres.

1. EXISTING ROADS:

- A. See attached Wellsite Plats showing directional reference stakes on location, and attached TOPO Map "B" showing access to location from existing roads.
- B. The proposed well site is located approximately 39.3 miles south of Vernal, Utah – See attached TOPO Map "A".
- C. Refer to attached Topographic Map "A" showing labeled access route to location.
- D. Existing roads will be maintained and repaired as necessary.

2. PLANNED ACCESS ROAD:

- A. The access road will be approximately 1584' in length. Two low water crossings with two (2) 24"x40' CMP's shall be installed on the major drainage crossings.
- B. The access road has a 30 foot ROW w/18 foot running surface.
- C. Maximum grade of the new access road will be 8 percent.
- D. No turnouts will be required.
- E. Road drainage crossings shall be of the typical dry creek drainage crossing type.
- F. No bridges, or major cuts and fills will be required.
- G. The access road will be dirt surface. Gravel shall be used as needed.
- H. No gates, cattleguards, or fences will be required or encountered.
- I. No permanent road right-of-way on Federal acreage is required.

All travel will be confined to existing access road right-of-way.

New or reconstructed roads will be centerlined – flagged at time of location staking.

The road shall be constructed/upgraded to meet the standards to the anticipated traffic flow and all-weather road requirements. Construction/upgrading shall include ditching, draining, graveling, crowning, and capping the roadbed as necessary to provide a well constructed safe road. Prior to upgrading the road shall be cleared of any snow cover and allowed to dry completely. Traveling off the 30 foot right-of-way will not be allowed. Road drainage

crossings shall be of the typical dry creek drainage crossing type. Crossings shall be designed so they will not cause siltation or accumulation or debris in the drainage crossings nor shall the drainages be blocked by the roadbed. Erosion of drainage ditches by run off water shall be prevented by diverting water off at frequent intervals by means of cutouts. Upgrading shall not be allowed during muddy conditions. Should mud holes develop, they shall be filled in and detours around them avoided.

As operator, EOG Resources, Inc. shall be responsible for all maintenance on cattleguards, or gates associated with this oil and/or gas operation.

The access road and associated drainage structures will be constructed and maintained in accordance with road guidelines contained in the joint BLM/USFS publication: Surface Operating Standards for Oil and Gas Exploration and Development, Third Edition, and/or BLM Manual Section 9113 concerning road construction standards on projects subject to federal jurisdiction. During the drilling and production phase of operations, the road surface and shoulders will be kept in a safe and useable condition and drainage ditches and culverts will be kept clear and free flowing.

3. LOCATION OF EXISTING WELLS WITHIN A ONE-MILE RADIUS:

See attached TOPO map "C" for the location of wells within a one-mile radius.

4. LOCATION OF EXISTING AND/OR PROPOSED PRODUCTION FACILITIES:

A. On Well Pad

1. Production facilities will be set on location if the well is successfully completed for production. Facilities will consist of wellhead valves, combo separator-dehy unit with meter, two (2) 400 BBL vertical tanks and attaching piping.
2. Gas gathering lines – A 4" gathering line will be buried from dehy to the edge of the location.
3. The area inside the anchors where truck traffic will occur shall be graveled as needed.

B. Off Well Pad

1. Proposed location of attendant off pad flowlines shall be flagged prior to archaeological clearance.
2. The length of the new proposed pipeline is 1860' x 40'. The proposed pipeline leaves the southern edge of the well pad Section 30, T8S, R23E (Lease UTU 61400) proceeding in a southeasterly direction for an approximate distance of 1860' tying into an existing pipeline located in the SESW of Section 30, T8S, R23E. Pipe will be 4" NOM, 0.156 wall, Grade X42, Zap-Lok, electric weld with a 35 mil X-Tru coating.

An off lease right-of-way will not be required.

3. Proposed pipeline will be a 4" OD steel, Zap-Lok line laid on the surface.
4. Protective measures and devices for livestock and wildlife will be taken and /or installed where required.

If storage facilities/tank batteries are constructed on this lease, the facility/battery or the well pad shall be surrounded by a containment dike of sufficient capacity to contain, at a minimum, the entire contents of the largest tank within the facility/battery, unless more stringent protective requirements are deemed necessary by the authorized officer.

All permanent (on site for six months or longer) structures constructed or installed (including pumping units) will be painted a flat, non-reflective, earthtone color to match one of the standard environmental colors, as determined by the Rocky Mountain Five State Interagency Committee. All facilities will be painted within 6 months of installation. **All existing facilities will be painted with Carlsbad Canyon.** Facilities required to comply with O.S.H.A. (Occupational Safety and Health Act) will be excluded.

5. LOCATION AND TYPE OF WATER SUPPLY:

- A. Water supply will be from Ouray Municipal Water Plant at Ouray, Utah, and/ or Target Trucking Inc.'s water source in the SW/SW. Sec 35, T9S, R22E Uintah County, Utah (State Water Right # 49-1501, and/or Bonanza Power Plant water source in Sec 26, T8S, R23E Uintah County, UT (State Water Right # 49-225(A31368)). Water will be hauled by a licensed trucking company.
- B. Water will be hauled by a licensed trucking company.
- C. No water well will be drilled on lease.

6. SOURCE OF CONSTRUCTION MATERIALS:

- A. All construction material for this location and access road will be of native borrow and soil accumulated during the construction of the location.
- B. No mineral materials will be required.

7. METHODS OF HANDLING WASTE DISPOSAL:

A. METHODS AND LOCATION

1. Cuttings will be confined in the reserve pit.
2. A portable toilet will be provided for human waste during the drilling and completion of the well. Disposal will be at the Vernal sewage disposal plant.
3. Burning will not be allowed. Trash and other waste material will be contained in a wire mesh cage and disposed of at the Uintah County Landfill.

4. Produced wastewater will be confined to a lined pit or storage tank for a period not to exceed 90 days after initial production. After the 90 day period, the produced water will be contained in a tank on location and then disposed of at one of the following three locations: Natural Buttes Unit 21-20B SWD, Ace Disposal, or EOG Resources, Inc. drilling operations (Chapita Wells Unit, Natural Buttes Unit & Stagecoach Unit).
 5. All chemicals will be disposed of at an authorized disposal site. Drip pans and absorbent pads will be used on the drilling rig to avoid leakage of oil to the pit.
- B. Water from drilling fluids and recovered during testing operations will be disposed of by either evaporating in the reserve pit or by removed and disposed of at an authorized disposal site. Introduction of well bore hydrocarbons to the reserve pit will be avoided by flaring them off in the flare pit at the time of recovery.

The reserve pit will be constructed so as not to leak, break, or allow discharge. If the reserve pit requires padding prior to lining (due to rocky conditions) felt padding will be used.

The reserve pit shall be lined with felt and a 12 millimeter plastic liner.

EOG Resources, Inc. maintains a file, per 29 CFR 1910.1200 (g) containing current Material Safety Data Sheets (MSDS) for all chemicals, compounds, and/or substances which are used during the course of construction, drilling, completion, and production operations for this project. Hazardous materials (substances) which may be found at the site may include drilling mud and cementing products which are primarily inhalation hazards, fuels (flammable and/or combustible), materials that may be necessary for well completion/ stimulation activities such as flammable or combustible substances and acids/gels (corrosives). The opportunity for Superfund Amendments and Reauthorization Act (SARA) listed Extremely Hazardous Substances (EHS) at the site is generally limited to proprietary treating chemicals. All hazardous and EHS and commercial preparations will be handled in an appropriate manner to minimize the potential for leaks or spills to the environment.

8. ANCILLARY FACILITIES:

None anticipated.

9. WELL SITE LAYOUT:

- A. Refer to attached well site plat for related topography cuts and fills and cross sections.
- B. Refer to attached well site plat for rig layout and soil material stockpile location as approved on On-site.
- C. Refer to attached well site plat for rig orientation, parking areas, and access road.

The reserve pit will be located on the west corner of the location. The flare pit will be located downwind of the prevailing wind direction on the south side of the location, a minimum of 100 feet from the well head and 30 feet from the reserve pit fence.

The stockpiled pit topsoil will be stored separate from the location topsoil north of corner #5. The stockpiled location topsoil will be stored between corners #2 and #8. Upon completion of construction, the stockpiled topsoil from the location will be broadcast seeded with the approved seed mixture from this location and then walked down with a Caterpillar tractor.

Access to the well pad will be from the east.

FENCING REQUIREMENTS:

All pits will be fenced according to the following minimum standards:

- A. Thirty-nine inch net wire shall be used with at least one strand of barbed wire on top of the net wire. (Barbed wire is not necessary if pipe or some type of reinforcement rod is attached to the top of the entire fence.)
- B. The net wire shall be no more than 2 inches above the ground. The barbed wire strand shall be 3 inches above the net wire. Total height of the fence shall be at least 42 inches.
- C. Corner posts shall be cemented and/or braced in such a manner as to keep the fence tight at all times.
- D. Standard steel, wood, or pipe posts shall be used between the corner braces. Maximum distances between any two posts shall be no greater than 16 feet.
- E. All wire shall be stretched by using a stretching device before it is attached to the corner posts.

The reserve pit fencing will be on the three sides during drilling operations and on the fourth side when the rig moves off location. Pits will be fenced and maintained until clean-up.

Each existing fence to be crossed by the access road shall be braced and tied off before cutting so as to prevent slacking of the wire. The opening shall be closed temporarily as necessary during construction to prevent the escape of livestock, and, upon completion of construction, the fence shall be repaired to BLM or SMA specifications. A cattleguard with an adjacent 16 foot gate shall be installed in any fence where a road is regularly traveled. If the well is a producer, the cattleguards (shall/shall not) be permanently counted on concrete bases. Prior to crossing any fence located on Federal land, or any fence between Federal land and private land, the operator will contact the BLM, who will in turn contact the grazing permittee or owner of said fence and offer him/her the opportunity to be present when the fence is cut in order to satisfy himself/herself that the fence is adequately braced and tied off.

10. PLANS FOR RECLAMATION OF THE SURFACE:

A. Producing Location

Immediately upon well completion, the location and surrounding area will be cleared of all unused tubing, equipment, debris, materials, trash, and junk not required for production.

Immediately upon well completion, any hydrocarbons on the pit shall be removed in accordance with CFR 3162.7-1.

If a plastic nylon reinforced liner is used, it shall be torn and perforated before backfilling of the reserve pit.

The reserve pit and that portion of the location not needed for production facilities/operations will be recontoured to the approximate natural contours. The stockpiled pit topsoil will then be spread over the pit area and broadcast seeded with the prescribed seed mixture for this location. The seeded area will then be walked down with a cat.

Seed Mixture	Drilled Rate (lbs./acre PLS*)
Crested Wheatgrass	9.0
Prostrate Kochia	3.0

*Pure live seed (PLS) formula: percent of purity of seed mixture times percent germination of seed mixture equals portion of seed mixture that is PLS.

B. Dry Hole/Abandoned Location

At such time as the well is plugged and abandoned, the operator will submit a subsequent report of abandonment and the BLM will attach the appropriated surface rehabilitation conditions of approval.

Seed Mixture	Drilled Rate (lbs./acre PLS*)
Gardner saltbush	3.0
Shadscale	3.0
Crested Wheatgrass	3.0

*Pure live seed (PLS) formula: percent of purity of seed mixture times percent germination of seed mixture equals portion of seed mixture that is PLS.

11. SURFACE OWNERSHIP:

Surface ownership of the proposed well site, access road, and pipeline route is as follows:

Bureau of Land Management

12. OTHER INFORMATION:

- A. EOG Resources, Inc. will inform all persons in the area who are associated with this project that they are subject to prosecution for knowingly disturbing historic or archaeological sites, or for collecting artifacts. If historic or archaeological materials are uncovered during construction, the operator will immediately stop work that might further disturb such materials, and contact the Authorized Officer. Within five working days the Authorized Officer will inform the operator as to:

- Whether the materials appear eligible for the National Register of Historic Places;
- The mitigation measures the operator will likely have to undertake before the site can be used.
- A time frame for the Authorized Officer to complete an expedited review under 36 CFR 800.11 to confirm, through the State Historic Preservation Officer, that the findings of the Authorized Officer are correct and that mitigation is appropriate.

If the operator wished, at any time, to relocate activities to avoid the expense of mitigation and/or the delays associated with this process, the Authorized Officer will assume responsibility for whatever recordation and stabilization of the exposed materials that may be required. Otherwise, the operator will be responsible for mitigation costs. The Authorized Officer will provide technical and procedural guidelines for the conduct of mitigation. Upon verification from the Authorized Officer that required mitigation has been completed, the operator will then be allowed to resume construction.

- B. As operator, EOG Resources, Inc. will control noxious weeds along Right-of-Ways for roads, pipelines, well sites, or other applicable facilities. A list of noxious weeds will be obtained from the BLM administered land, a Pesticide Use proposal shall be submitted, and given approval, prior to the application of herbicides or other pesticides or possible hazardous chemicals.
- C. The drilling rig and ancillary equipment will be removed from the location prior to commencement of completion operations. Completion operations will be conducted utilizing a completion/workover rig.
- D. Drilling rigs and/or equipment used during drilling operations on this well site will not be stacked or stored on BLM lands after the conclusion of drilling operations or at any other time without BLM authorization. However, if BLM authorization is obtained, it is only a temporary measure to allow time to make arrangements for permanent storage

on commercial facilities. (The BLM does not seek to compete with private industry. There are commercial facilities available for stacking and storing drilling rigs.)

All lease and/or unit operations will be conducted in such a manner that full compliance is made with all applicable laws, regulations, Onshore Oil and Gas Orders, the approved Plan of Operations, and any applicable Notice of Lessees. The operator is fully responsible for the actions of its subcontractors. A complete copy of the approved "Application for Permit to Drill" and "Right-of-Way grant", if applicable, will be furnished to the field representative(s) to ensure compliance and shall be on location during all construction and drilling operations.

Construction activity will not be conducted using frozen or saturated soils material or during periods when watershed damage is likely to occur.

If the existing access road, proposed access road, and proposed pad are dry during construction, drilling, and completion activities, water will be applied to help facilitate compaction during construction and to minimize soil loss as a result of wind erosion.

A cultural resources survey was conducted and submitted August 20, 2006 by Montgomery Archaeological Consultants. A Paleontology survey was conducted and will be submitted August 3, 2006 by Dr. Wade Miller.

Other Requirements:

One water diversion dam shall be constructed west of the pit.

Additional Surface Stipulations:

No construction or drilling will be allowed during the antelope kidding season of May 15 to June 20 unless clearance has been obtained by the BLM wildlife biologist.

Prior to any construction between February 1 and July 15, all areas within 0.5 mile of the proposed location shall be surveyed for golden eagles as well as other raptors. If active nests are identified, no surface disturbance will occur until the nest has been inactive for a two-year period. If no active nests are found within 0.5 mile of the proposed location, construction and drilling can occur.

LESSEE OR OPERATOR'S REPRESENTATIVE AND CERTIFICATION:

PERMITTING AGENT

Kaylene R. Gardner
EOG Resources, Inc.
P.O. Box 1815
Vernal, Ut 84078
(435) 781-9111

DRILLING OPERATIONS


Donald Presenkowski
EOG Resources, Inc.
P.O. Box 250
Big Piney, WY 83113
307-276-4865

I hereby certify that I, or persons under my direct supervision, have inspected the proposed drill site and access route; that I am familiar with the conditions which currently exist; that the statements made in this plan are, to the best of my knowledge, true and correct; and that the work associated with the operations proposed herein will be performed by EOG Resources, Inc. and its contractors and subcontractors in conformity with this plan and the terms and conditions under which it is approved. This statement is subject to the provisions of 18 U.S.C. 1001 for the filing of a false statement.

Please be advised that EOG Resources, Inc. is considered to be the operator of the Hoss 32-30 well, located in NWSW, of Section 30, T8S, R23E, Uintah County, Utah; Federal land and minerals; and is responsible under the terms and conditions of the lease for the operations conducted upon the leased lands. Bond Coverage is under Bond # NM 2308.

October 2, 2006

Date

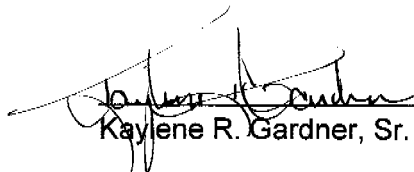
Kaylene R. Gardner, Sr. Regulatory Assistant

Request for Exception to Buried Pipeline Requirement
HOSS 32-30
NWSW, Sec. 30, T8S, R23E
UTU-61400

EOG Resources, Inc. requests a variance to the requirement for a buried gas sales pipeline for the referenced well for the following reasons:

1. In order to bury pipe on the gas sales line route, additional surface disturbance relative to surface pipeline would be approximately 50' X Length acres.
2. Ripping, cutting, or blasting of rock would be required, which in turn would leave long-term spoils on the right-of-way.
3. The disturbed soils on the pipeline corridor would be difficult to rehabilitate and would be susceptible to noxious weed infestation, which in turn would be hazardous to livestock.
4. Supplemental soil to replace removed rock would need to be hauled in from other locations to provide bedding and cover material.
5. The buried pipe would need to be coated and/or wrapped to minimize the potential for corrosion-caused gas leaks and blowouts.
6. Burying of pipe next to access roads increases the potential for damage, explosion, and fire when using graders and/or dozers for snow removal or road rehabilitation.
7. Surface equipment, including risers with blow down valves and pipeline markers will be required, adding to negative visual impact.
8. Disturbance of previously rehabilitated pipeline corridor could be necessary if increasing well density requires crossing of the corridor or location construction on the corridor.
9. Pipeline corridors subject to poor rehabilitation characteristics are susceptible to high rates of soil erosion.
10. Buried shallow pipelines in low areas subject to the occasional presence of standing water are susceptible to movement and surfacing.

EOG RESOURCES, INC.
HOSS #32-30
SECTION 30, T8S, R23E, S.L.B.&M.

PROCEED IN AN EASTERLY, THEN SOUTHEASTERLY DIRECTION FROM VERNAL, UTAH ALONG U.S. HIGHWAY 40 APPROXIMATELY 3.9 MILES TO THE JUNCTION OF STATE HIGHWAY 45; EXIT RIGHT AND PROCEED IN A SOUTHERLY, THEN SOUTHEASTERLY DIRECTION APPROXIMATELY 24.1 MILES ON STATE HIGHWAY 45 TO THE JUNCTION OF THIS ROAD AND AN EXISTING ROAD TO THE SOUTHWEST; TURN RIGHT AND PROCEED IN A SOUTHWESTERLY, THEN WESTERLY DIRECTION APPROXIMATELY 9.9 MILES TO THE JUNCTION OF THIS ROAD AND AN EXISTING ROAD TO THE NORTHEAST; TURN RIGHT AND PROCEED IN A NORTHEASTERLY DIRECTION APPROXIMATELY 0.8 MILES TO THE BEGINNING OF THE PROPOSED ACCESS FOR THE #24-30 TO THE NORTH; FOLLOW ROAD FLAGS IN A NORTHERLY DIRECTION APPROXIMATELY 0.1 MILES TO THE BEGINNING OF THE PROPOSED ACCESS FOR THE #27-30 TO THE NORTHWEST; FOLLOW ROAD FLAGS IN A NORTHWESTERLY DIRECTION APPROXIMATELY 0.1 MILES TO THE BEGINNING OF THE PROPOSED ACCESS FOR THE #31-30 TO THE NORTHEAST; FOLLOW ROAD FLAGS IN A NORTHEASTERLY DIRECTION APPROXIMATELY 0.1 MILES TO THE BEGINNING OF THE PROPOSED ACCESS TO THE NORTHWEST; FOLLOW ROAD FLAGS IN A NORTHWESTERLY DIRECTION APPROXIMATELY 0.3 MILES TO THE PROPOSED LOCATION.

TOTAL DISTANCE FROM VERNAL, UTAH TO THE PROPOSED WELL LOCATION IS APPROXIMATELY 39.3 MILES.

EOG RESOURCES, INC.

HOSS #32-30

LOCATED IN UINTAH COUNTY, UTAH
SECTION 30, T8S, R23E, S.L.B.&M.

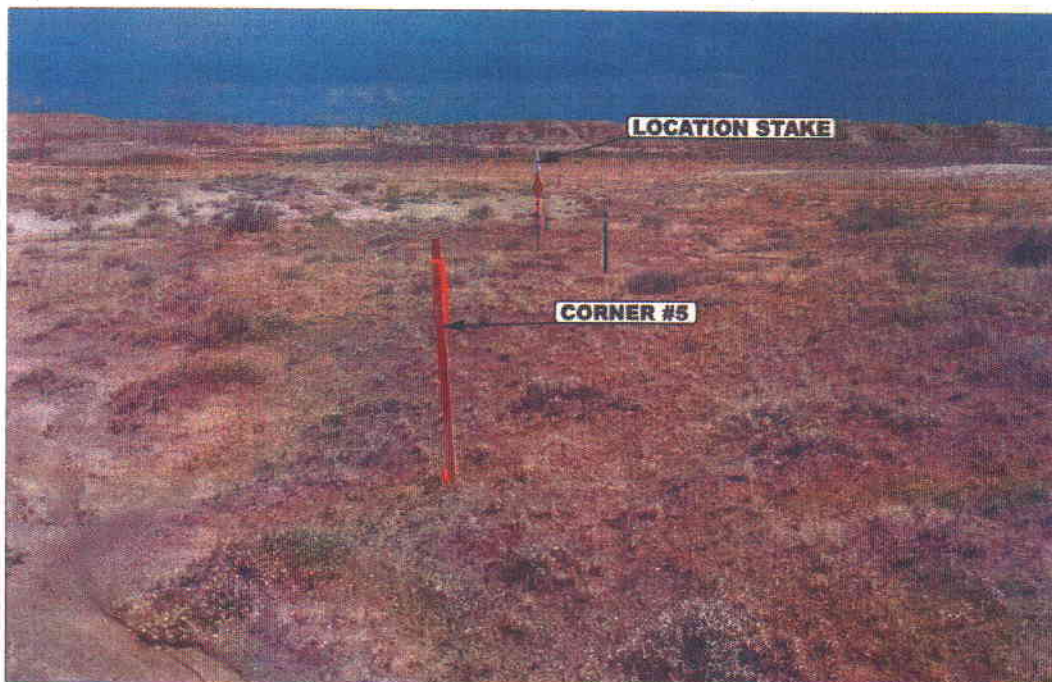


PHOTO: VIEW FROM CORNER #5 TO LOCATION STAKE

CAMERA ANGLE: SOUTHEASTERLY



PHOTO: VIEW FROM BEGINNING OF PROPOSED ACCESS

CAMERA ANGLE: NORTHWESTERLY



- Since 1964 -

UELS Uintah Engineering & Land Surveying
85 South 200 East Vernal, Utah 84078
435-789-1017 uels@uelsinc.com

LOCATION PHOTOS

07 06 06
MONTH DAY YEAR


PHOTO

TAKEN BY: T.A. DRAWN BY: C.P. REVISED: 00-00-00

EOG RESOURCES, INC.

LOCATION LAYOUT FOR

HOSS #32-30
SECTION 30, T8S, R23E, S.L.B.&M.
2050' FSL 480' FWL

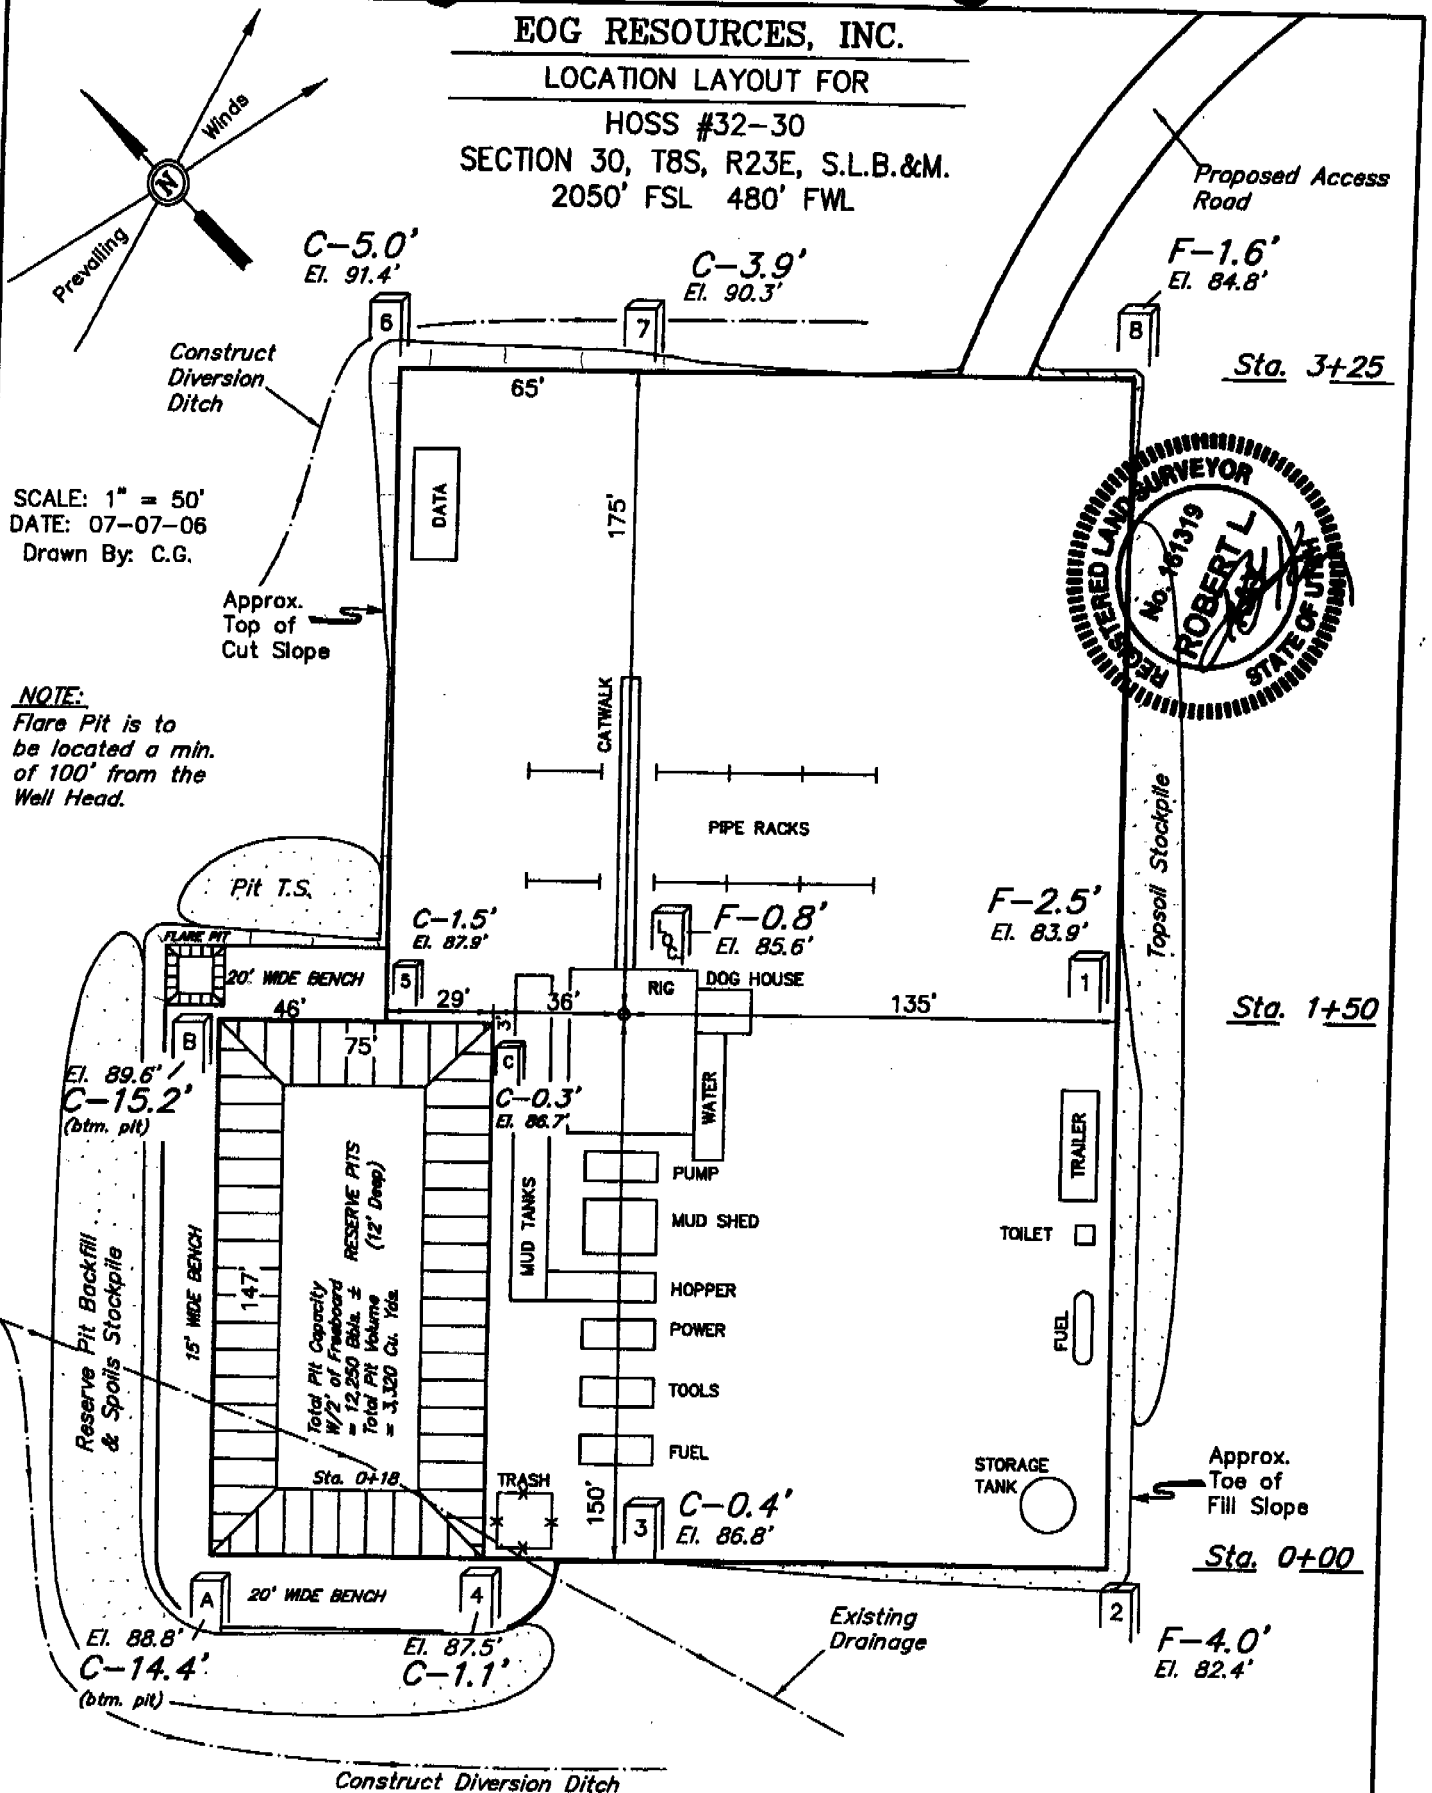

SCALE: 1" = 50'
DATE: 07-07-06
Drawn By: C.G.

NOTE:
Flare Pit is to be located a min. of 100' from the Well Head.



Elev. Ungraded Ground at Location Stake = 4885.6'
Elev. Graded Ground at Location Stake = 4886.4'

UINTAH ENGINEERING & LAND SURVEYING
85 So. 200 East • Vernal, Utah 84078 • (435) 789-1017

EOG RESOURCES, INC.

TYPICAL CROSS SECTIONS FOR

HOSS #32-30

SECTION 30, T8S, R23E, S.L.B.&M.





2050' FSL 480' FWL



1" = 20'
X-Section
Scale
1" = 50'

DATE: 07-07-06

Drawn By: C.G.

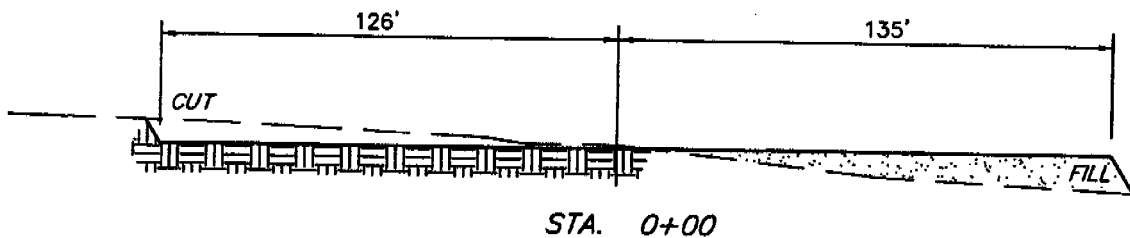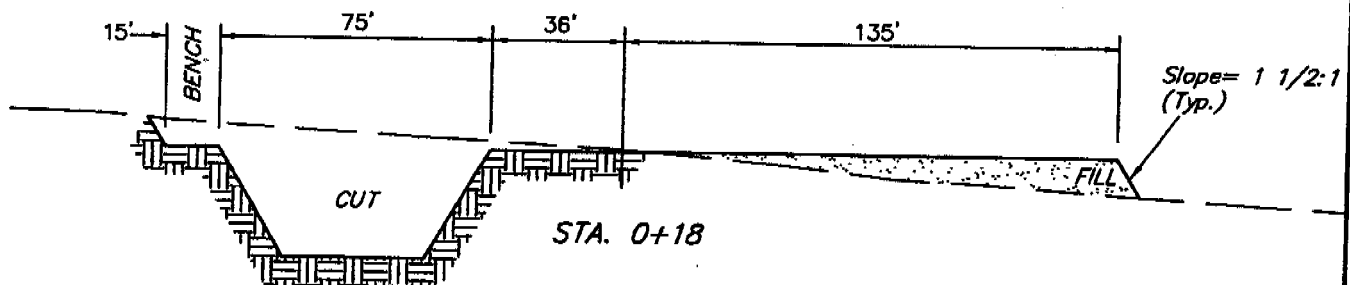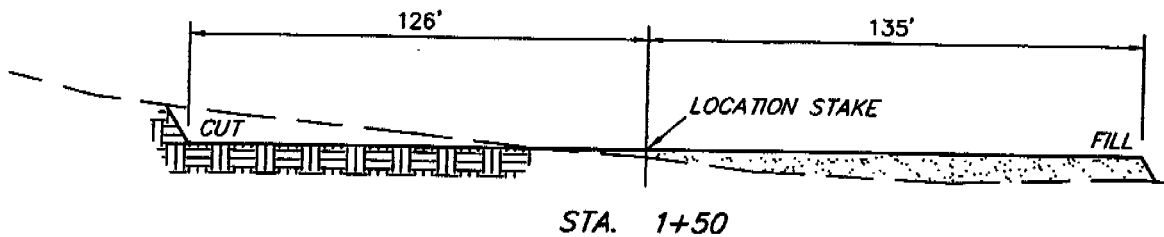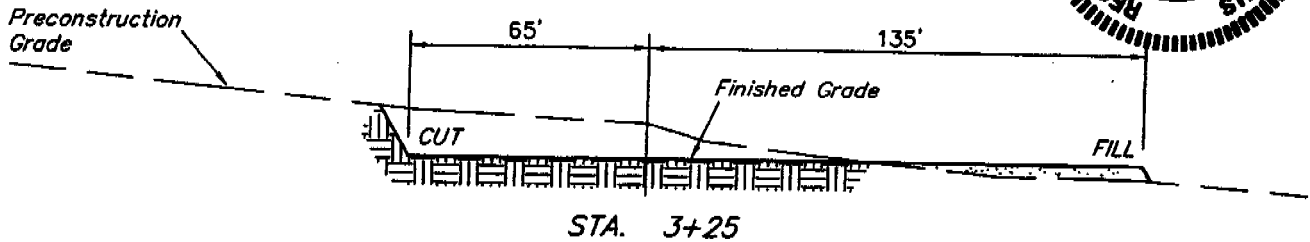


* NOTE:
FILL QUANTITY INCLUDES
5% FOR COMPACTION

APPROXIMATE YARDAGES

(6") Topsoil Stripping = 1,550 Cu. Yds.
Remaining Location = 5,120 Cu. Yds.
TOTAL CUT = 6,670 CU.YDS.
FILL = 3,460 CU.YDS.

EXCESS MATERIAL = 3,210 Cu. Yds.
Topsoil & Pit Backfill = 3,210 Cu. Yds.
(1/2 Pit Vol.)
EXCESS UNBALANCE = 0 Cu. Yds.
(After Rehabilitation)

UINTAH ENGINEERING & LAND SURVEYING
86 So. 200 East • Vernal, Utah 84078 • (435) 789-1017

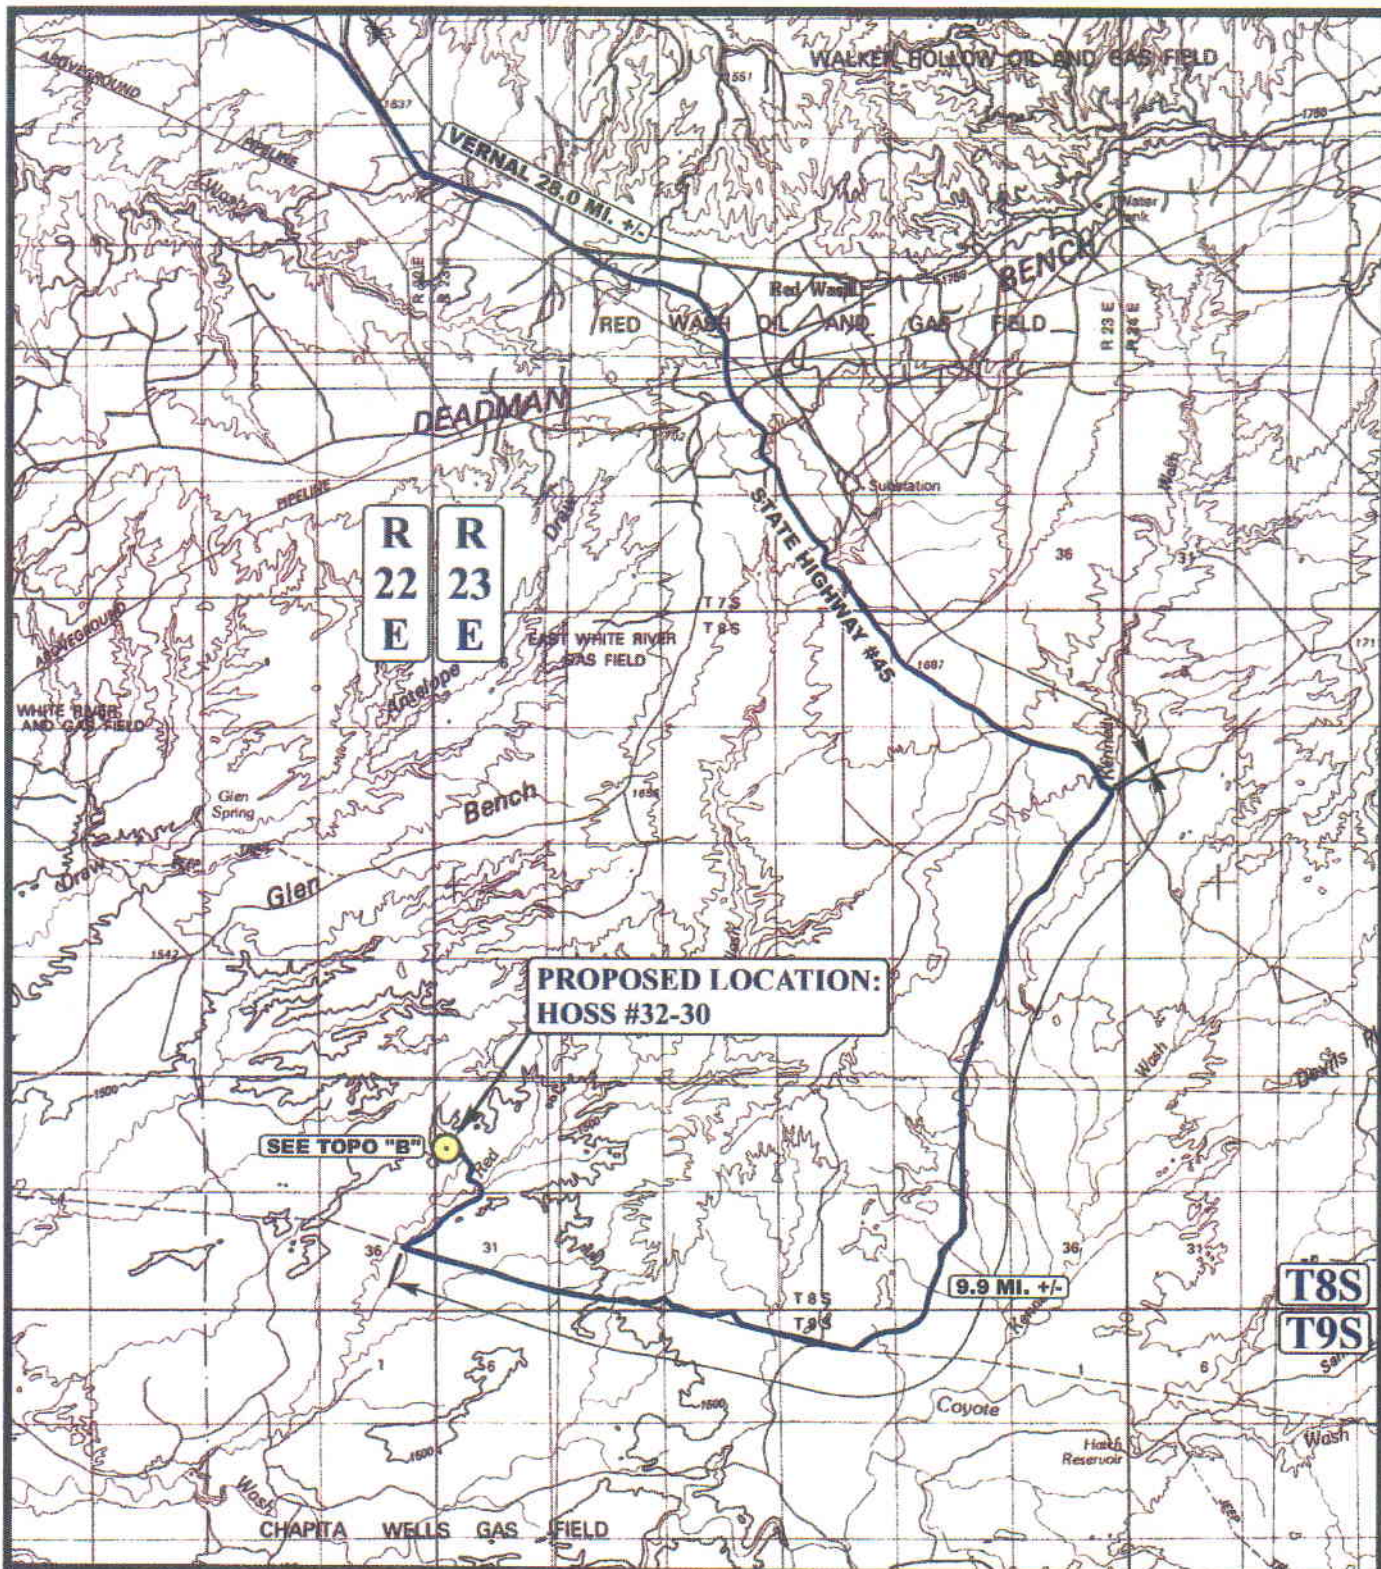

LEGEND:

PROPOSED LOCATION

EOG RESOURCES, INC.

HOSS #32-30
SECTION 30, T8S, R23E, S.L.B.&M.
2050' FSL 480' FWL



Utah Engineering & Land Surveying
 85 South 200 East Vernal, Utah 84078
 (435) 789-1017 * FAX (435) 789-1813




TOPOGRAPHIC
MAP

07 06 06
 MONTH DAY YEAR

SCALE: 1:100,000 DRAWN BY: C.P. REVISED: 00-00-00



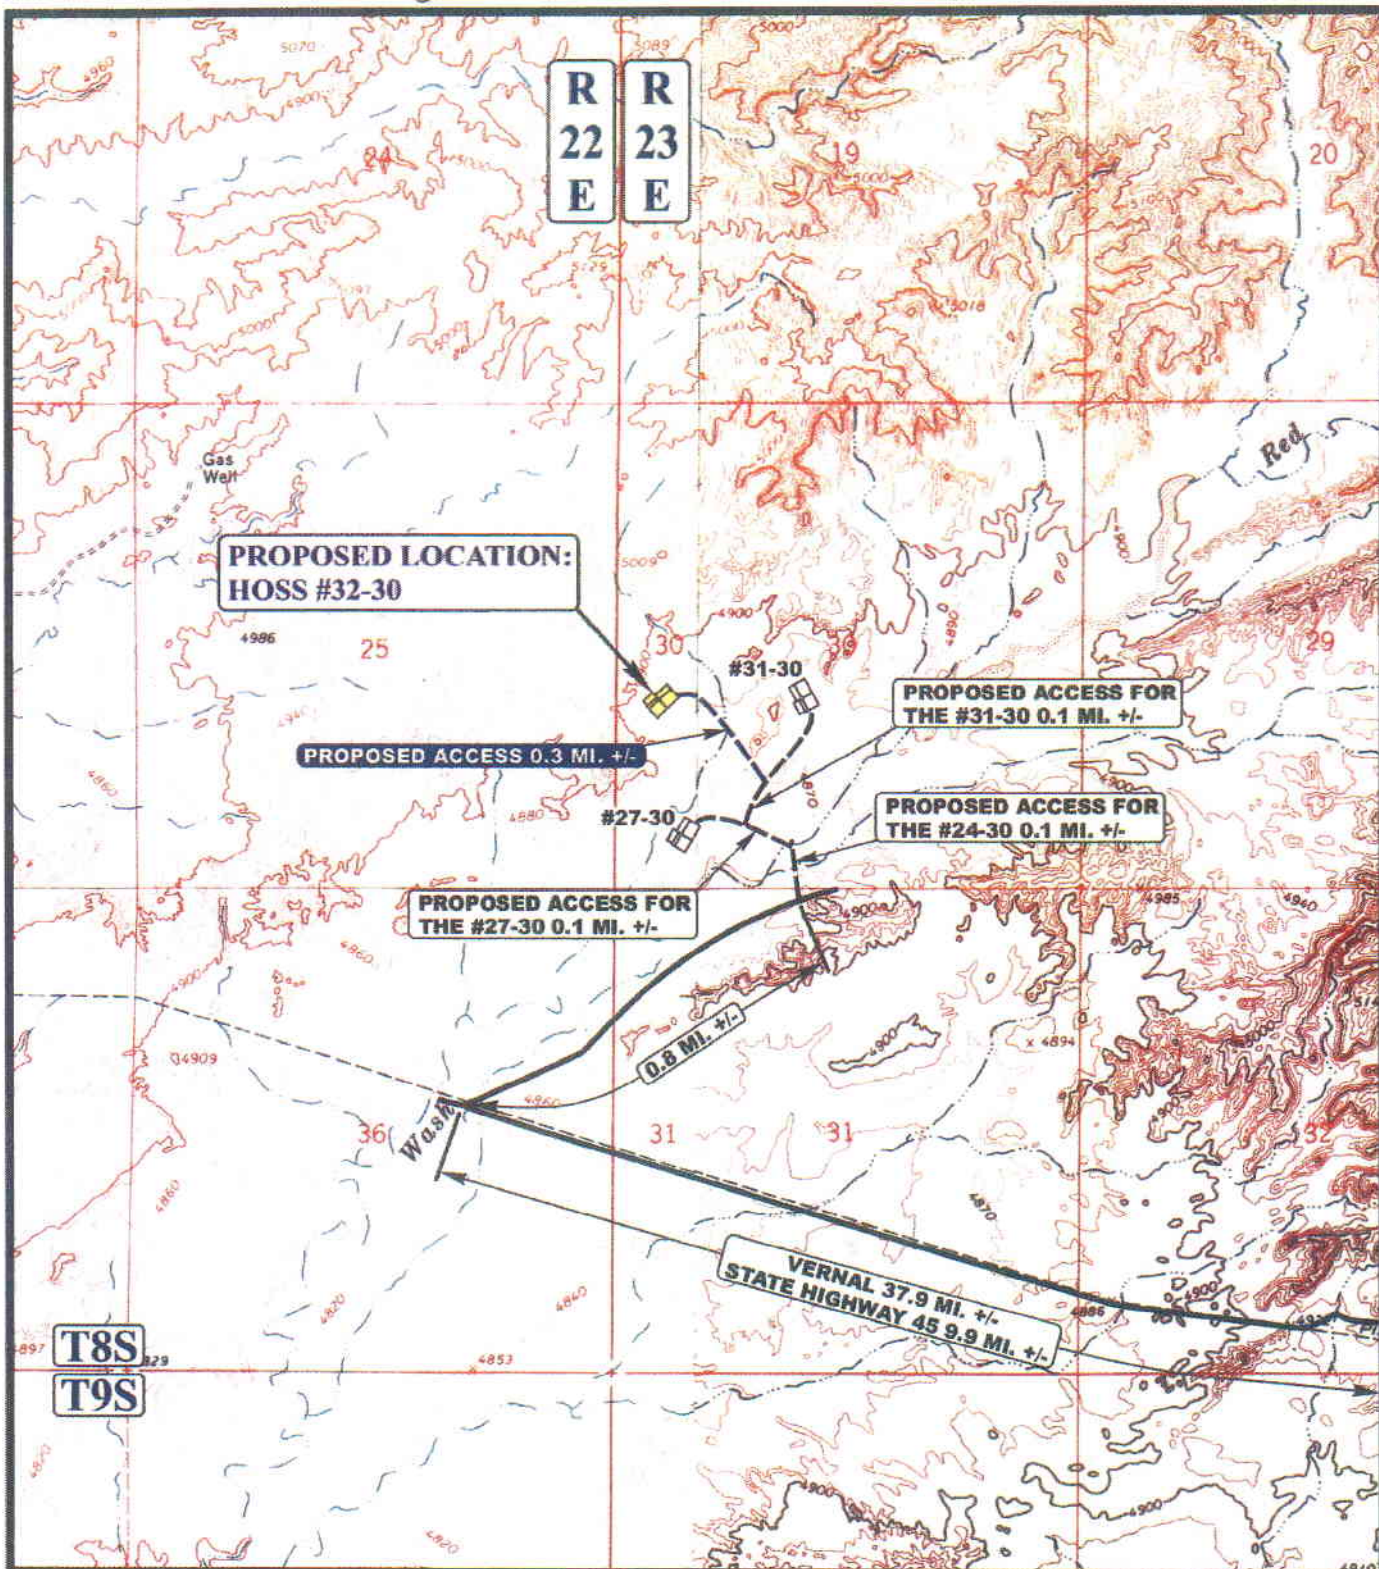

LEGEND:

— EXISTING ROAD
 - - - PROPOSED ACCESS ROAD

EOG RESOURCES, INC.

HOSS #32-30
SECTION 30, T8S, R23E, S.L.B.&M.
2050' FSL 480' FWL




Uintah Engineering & Land Surveying
 85 South 200 East Vernal, Utah 84078
 (435) 789-1017 * FAX (435) 789-1813



TOPOGRAPHIC MAP
 SCALE: 1" = 2000' DRAWN BY: C.P. REVISED: 00-00-00

B
TOPO

07 06 06
 MONTH DAY YEAR

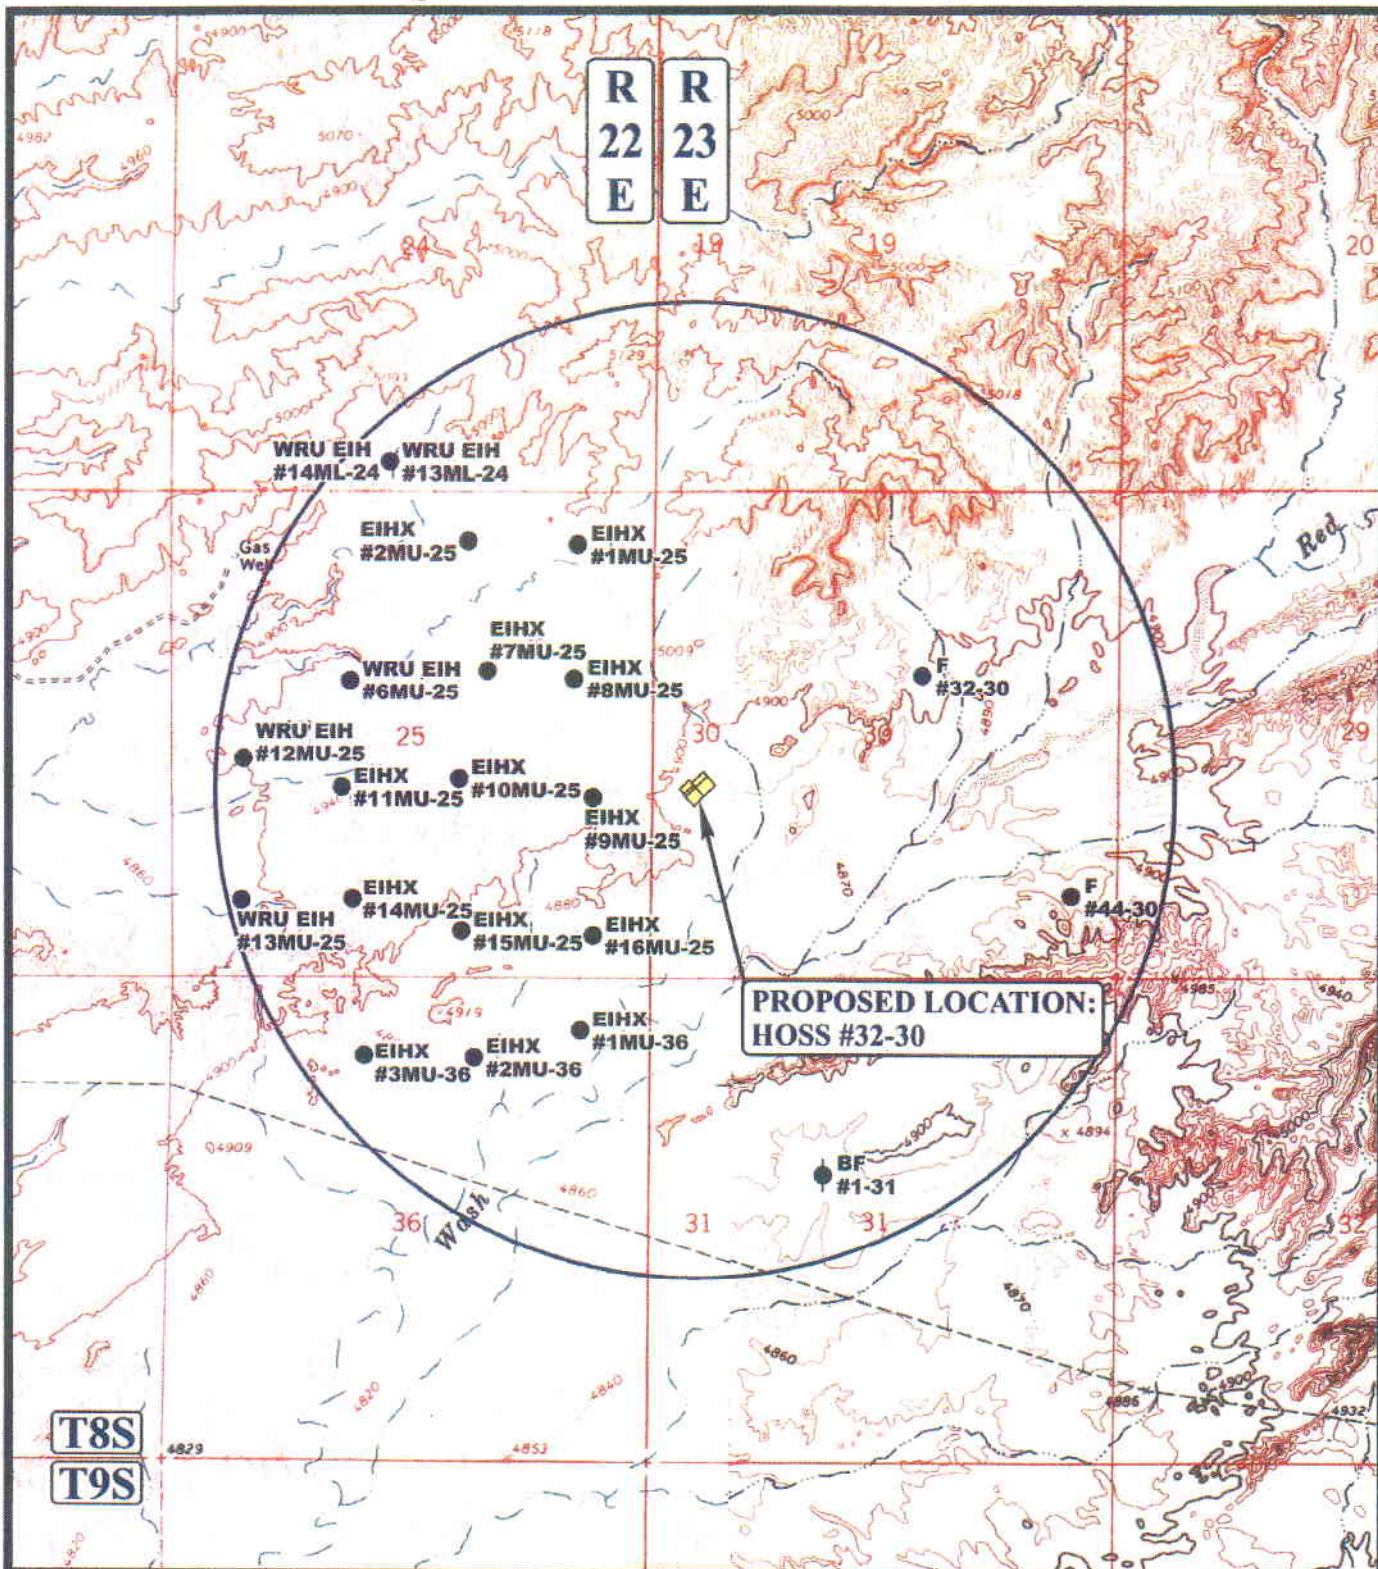

LEGEND:

- DISPOSAL WELLS
- PRODUCING WELLS
- SHUT IN WELLS
- WATER WELLS
- ABANDONED WELLS
- TEMPORARILY ABANDONED

U
E
L
S

Utah Engineering & Land Surveying
85 South 200 East Vernal, Utah 84078
(435) 789-1017 * FAX (435) 789-1813

EOG RESOURCES, INC.


HOSS #32-30
SECTION 30, T8S, R23E, S.L.B.&M.
2050' FSL 480' FWL

TOPOGRAPHIC
MAP

07 06 06
MONTH DAY YEAR

C
TOPO

SCALE: 1" = 2000' DRAWN BY: C.P. REVISED: 00-00-00

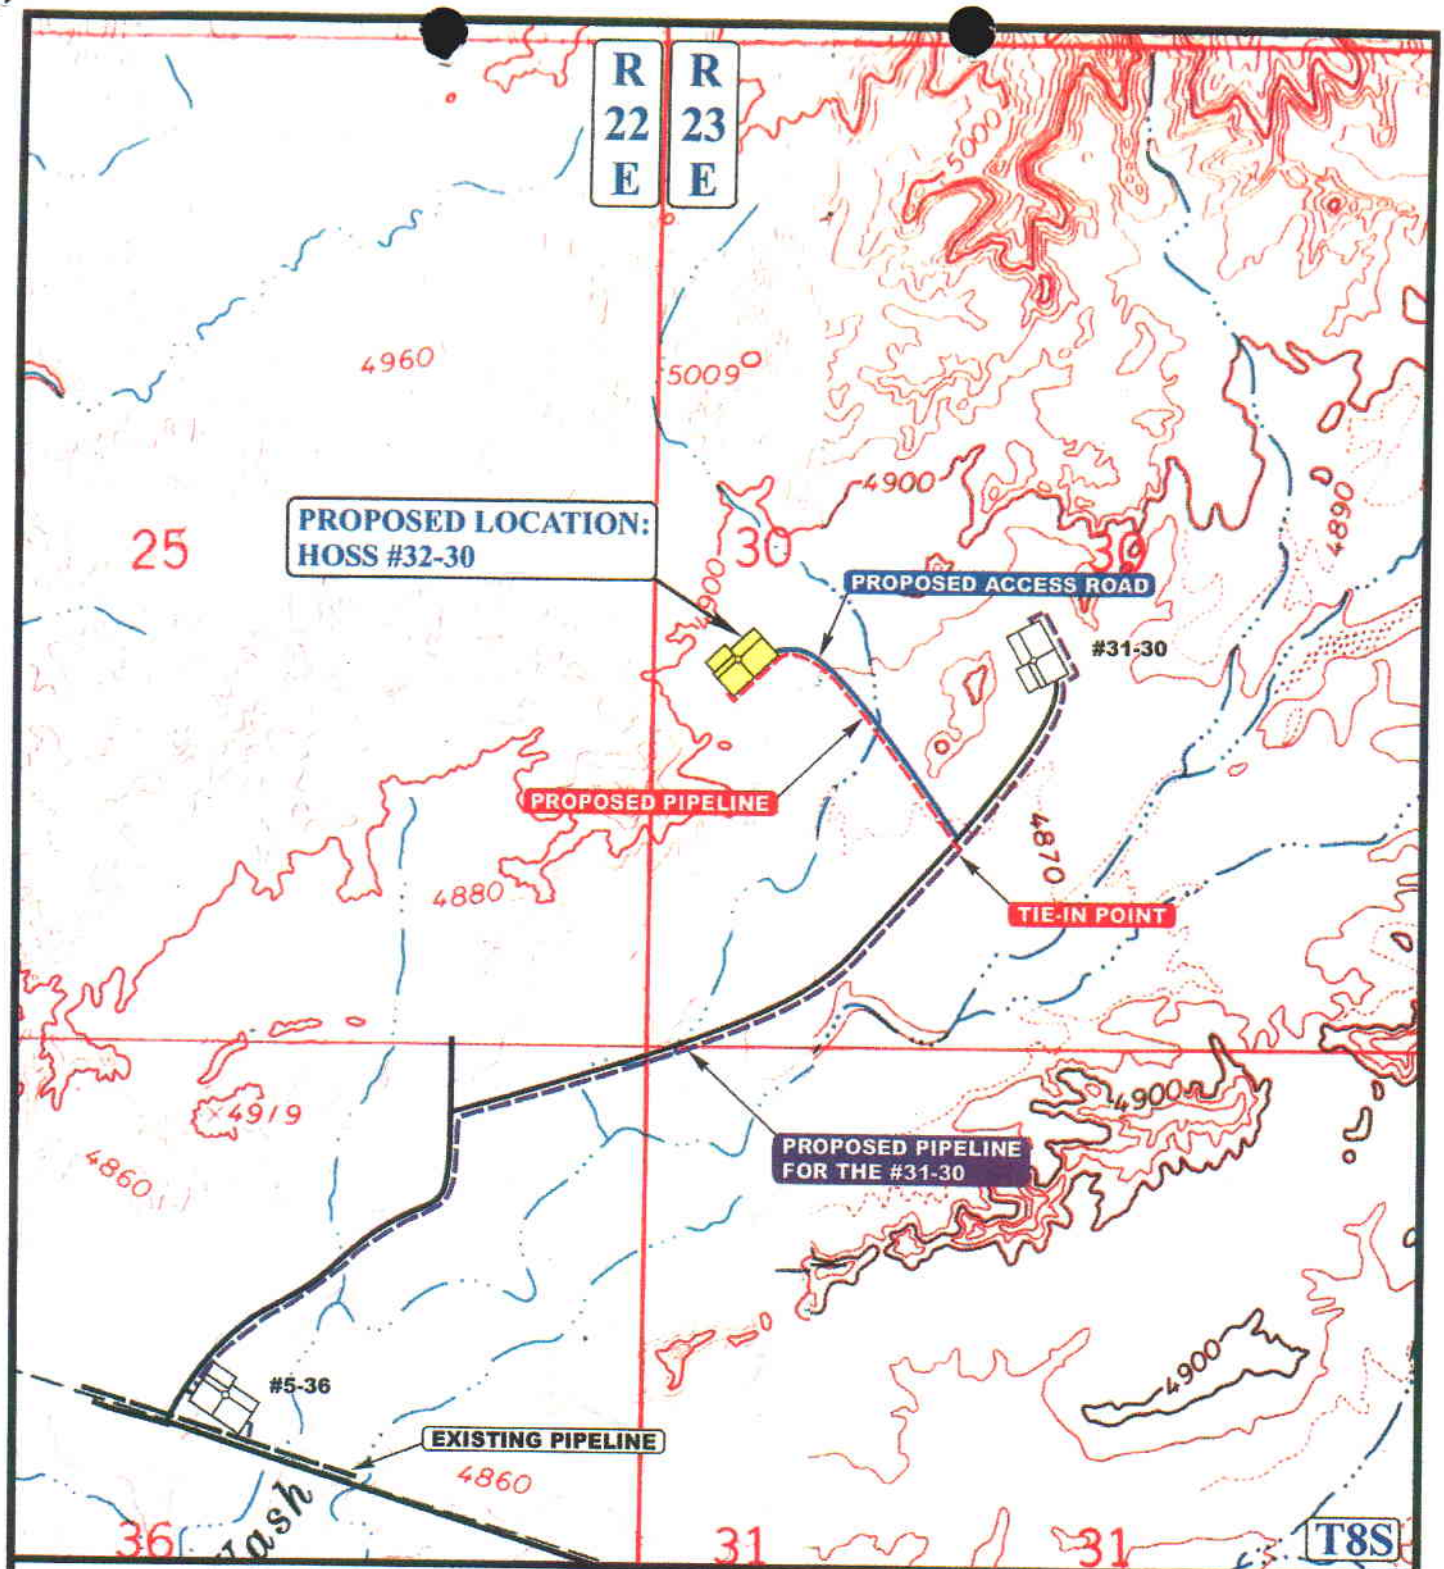

APPROXIMATE TOTAL PIPELINE DISTANCE = 1860' +/-

LEGEND:

- PROPOSED ACCESS ROAD
- EXISTING PIPELINE
- - - - - PROPOSED PIPELINE
- - - - - PROPOSED PIPELINE (SERVICING OTHER WELLS)

N

EOG RESOURCES, INC.

HOSS #32-30

SECTION 30, T8S, R23E, S.L.B.&M.

2050' FSL 480' FWL

**TOPOGRAPHIC
MAP**

09 13 06
MONTH DAY YEAR

**D
TOPO**

SCALE: 1" = 1000' **DRAWN BY: C.H.** **REVISED: 00-00-00**

UELS

Uintah Engineering & Land Surveying
85 South 200 East Vernal, Utah 84078
(435) 789-1017 * FAX (435) 789-1813

WORKSHEET
APPLICATION FOR PERMIT TO DRILL

APD RECEIVED: 10/10/2006

API NO. ASSIGNED: 43-047-38701

WELL NAME: HOSS 32-30

OPERATOR: EOG RESOURCES INC (N9550)

PHONE NUMBER: 435-781-9111

CONTACT: KAYLENE GARDNER

PROPOSED LOCATION:

NWSW 30 080S 230E

SURFACE: 2050 FSL 0480 FWL

BOTTOM: 2050 FSL 0480 FWL

COUNTY: Uintah

LATITUDE: 40.09213 LONGITUDE: -109.3765

UTM SURF EASTINGS: 638401 NORTHINGS: 4439035

FIELD NAME: NATURAL BUTTES (630)

INSPECT LOCATN BY: / /		
Tech Review	Initials	Date
Engineering	DKD	10/26/06
Geology		
Surface		

LEASE TYPE: 1 - Federal

LEASE NUMBER: UTU 61400

SURFACE OWNER: 1 - Federal

PROPOSED FORMATION: PRRV

COALBED METHANE WELL? NO

RECEIVED AND/OR REVIEWED:

☒ Plat
☒ Bond: Fed[1] Ind[] Sta[] Fee[]
(No. NM 2308)
☒ Potash (Y/N)
☒ Oil Shale 190-5 (B) or 190-3 or 190-13
☒ Water Permit
(No. 49-1501)
☒ RDCC Review (Y/N)
(Date:)
☒ Fee Surf Agreement (Y/N)
☒ Intent to Commingle (Y/N)
(Wasatch, Mesaverde)

LOCATION AND SITING:

___ R649-2-3.
Unit: ___
☒ R649-3-2. General
Siting: 460 From Qtr/Qtr & 920' Between Wells
___ R649-3-3. Exception
___ Drilling Unit
Board Cause No: ___
Eff Date: ___
Siting: ___
___ R649-3-11. Directional Drill

COMMENTS: _____

STIPULATIONS: _____

1 - Federal Approval
2 - Spacing Strip
3 - Commencing



State of Utah

**Department of
Natural Resources**

MICHAEL R. STYLER
Executive Director

**Division of
Oil, Gas & Mining**

JOHN R. BAZA
Division Director

JON M. HUNTSMAN, JR.
Governor

GARY R. HERBERT
Lieutenant Governor

October 26, 2006

EOG Resources Inc.
1060 East Highway 40
Vernal, UT 84078

Re: Hoss 32-30 Well, 2050' FSL, 480' FWL, NW SW, Sec. 30, T. 8 South,
R. 23 East, Uintah County, Utah

Gentlemen:

Pursuant to the provisions and requirements of Utah Code Ann. § 40-6-1 *et seq.*, Utah Administrative Code R649-3-1 *et seq.*, and the attached Conditions of Approval, approval to drill the referenced well is granted.

This approval shall expire one year from the above date unless substantial and continuous operation is underway, or a request for extension is made prior to the expiration date. The API identification number assigned to this well is 43-047-38701.

Administrative approval for commingling the production from the Wasatch formation and the Mesaverde formation in this well is hereby granted. Appropriate information has been submitted to DOGM in accordance with R649-3-22. No written objections from owners were received by DOGM.

Sincerely,

A handwritten signature in black ink, appearing to read "Gil Hunt".

Gil Hunt
Associate Director

pab
Enclosures

cc: Uintah County Assessor
Bureau of Land Management, Vernal District Office

Operator: EOG Resources Inc.
Well Name & Number Hoss 32-30
API Number: 43-047-38701
Lease: UTU-61400

Location: NW SW Sec. 30 T. 8 South R. 23 East

Conditions of Approval

1. General

Compliance with the requirements of Utah Admin. R. 649-1 *et seq.*, the Oil and Gas Conservation General Rules, and the applicable terms and provisions of the approved Application for permit to drill.

2. Notification Requirements

Notify the Division within 24 hours of spudding the well.

- Contact Carol Daniels at (801) 538-5284.

Notify the Division prior to commencing operations to plug and abandon the well.

- Contact Dan Jarvis at (801) 538-5338

3. Reporting Requirements

All required reports, forms and submittals will be promptly filed with the Division, including but not limited to the Entity Action Form (Form 6), Report of Water Encountered During Drilling (Form 7), Weekly Progress Reports for drilling and completion operations, and Sundry Notices and Reports on Wells requesting approval of change of plans or other operational actions.

4. State approval of this well does not supersede the required federal approval, which must be obtained prior to drilling.

5. This proposed well is located in an area for which drilling units (well spacing patterns) have not been established through an order of the Board of Oil, Gas and Mining (the "Board"). In order to avoid the possibility of waste or injury to correlative rights, the operator is requested, once the well has been drilled, completed, and has produced, to analyze geological and engineering data generated therefrom, as well as any similar data from surrounding areas if available. As soon as is practicable after completion of its analysis, and if the analysis suggests an area larger than the quarter-quarter section upon which the well is located is being drained, the operator is requested to seek an appropriate order from the Board establishing drilling and spacing units in conformance with such analysis by filing a Request for Agency Action with the Board.

RECEIVED

OCT - 2 2006

Form 3160-3
(February 2005)

FORM APPROVED
OMB No. 1004-0137
Expires March 31, 2007

UNITED STATES
DEPARTMENT OF THE INTERIOR
BUREAU OF LAND MANAGEMENT

BLM VERNAL, UTAH

APPLICATION FOR PERMIT TO DRILL OR REENTER

1a. Type of work: <input checked="" type="checkbox"/> DRILL <input type="checkbox"/> REENTER		5. Lease Serial No. UTU 61400
1b. Type of Well: <input type="checkbox"/> Oil Well <input checked="" type="checkbox"/> Gas Well <input type="checkbox"/> Other <input type="checkbox"/> Single Zone <input checked="" type="checkbox"/> Multiple Zone		6. If Indian, Allottee or Tribe Name
2. Name of Operator EOG RESOURCES, INC		7. If Unit or CA Agreement, Name and No.
3a. Address 1060 EAST HIGHWAY 40 VERNAL, UT 84078	3b. Phone No. (include area code) 435-781-9111	8. Lease Name and Well No. HOSS 32-30
4. Location of Well (Report location clearly and in accordance with any State requirements.) At surface 2050 FSL 480 FWL NWSW 40.082106 LAT 109.377192 LON At proposed prod. zone SAME		9. API Well No. 43-047-38701
11. Sec., T. R. M. or Blk. and Survey or Area Lot 3 SECTION 30, T8S, R23E S.L.B.&M		10. Field and Pool, or Exploratory NATURAL BUTTES
12. County or Parish UINTAH		13. State UT
14. Distance in miles and direction from nearest town or post office* 39.3 MILES SOUTH OF VERNAL, UTAH		
15. Distance from proposed* location to nearest property or lease line, ft. (Also to nearest drig. unit line, if any) 480 LEASE LINE 480 DRILLING LINE	16. No. of acres in lease 628	17. Spacing Unit dedicated to this well 37
18. Distance from proposed location* to nearest well, drilling, completed, applied for, on this lease, ft. 6200	19. Proposed Depth 10,035	20. BLM BIA Bond No. on file NM 2308
21. Elevations (Show whether DF, KDB, RT, GL, etc.) 4886 GL	22. Approximate date work will start*	23. Estimated duration 45 DAYS

24. Attachments

The following, completed in accordance with the requirements of Onshore Oil and Gas Order No. 1, must be attached to this form:

- | | |
|--|---|
| 1. Well plat certified by a registered surveyor. | 4. Bond to cover the operations unless covered by an existing bond on file (see Item 20 above). |
| 2. A Drilling Plan. | 5. Operator certification |
| 3. A Surface Use Plan (if the location is on National Forest System Lands, the SUPO must be filed with the appropriate Forest Service Office). | 6. Such other site specific information and/or plans as may be required by the BLM. |

25. Signature 	Name (Printed Typed) KAYLENE R. GARDNER	Date 10/02/2006
Title SR. REGULATORY ASSISTANT		
Approved by (Signature) 	Name (Printed Typed) JERRY KEWCZKA	Date 12-18-2006
Title Assistant Field Manager Lands & Mineral Resources	Office VERNAL FIELD OFFICE	

Application approval does not warrant or certify that the applicant holds legal or equitable title to those rights in the subject lease which would entitle the applicant to conduct operations thereon.
Conditions of approval, if any, are attached.

Title 18 U.S.C. Section 1001 and Title 43 U.S.C. Section 1212, make it a crime for any person knowingly and willfully to make to any department or agency of the United States any false, fictitious or fraudulent statements or representations as to any matter within its jurisdiction.

*(Instructions on page 2)

CONDITIONS OF APPROVAL ATTACHED

NOTICE OF APPROVAL

RECEIVED

DEC 21 2006

DIV. OF OIL, GAS & MINING

06BM 1849 A

UOS 7/20/06



UNITED STATES DEPARTMENT OF THE INTERIOR
BUREAU OF LAND MANAGEMENT
VERNAL FIELD OFFICE

170 South 500 East

VERNAL, UT 84078

(435) 781-4400



CONDITIONS OF APPROVAL FOR APPLICATION FOR PERMIT TO DRILL

Company:	EOG Resources	Location:	Lot 3 Sec 30, T8S, R23E
Well No:	HOSS 32-30	Lease No:	UTU-61400
API No:	43-047-38701	Agreement:	N/A

Petroleum Engineer:	Matt Baker	Office: 435-781-4490	Cell: 435-828-4470
Petroleum Engineer:	Michael Lee	Office: 435-781-4432	Cell: 435-828-7875
Petroleum Engineer:	Jim Ashley	Office: 435-781-4470	Cell: 435-828-7874
Supervisory Petroleum Technician:	Jamie Sparger	Office: 435-781-4502	Cell: 435-828-3913
Environmental Scientist:	Paul Buhler	Office: 435-781-4475	Cell: 435-828-4029
Environmental Scientist:	Karl Wright	Office: 435-781-4484	
NRS/Enviro Scientist	Chuck MacDonald	Office: 435-781-4441	
Natural Resource Specialist:	Holly Villa	Office: 435-781-4404	
Natural Resource Specialist:	Melissa Hawk	Office: 435-781-4476	
Natural Resource Specialist:	Scott Ackerman	Office: 435-781-4437	
After Hours Contact Number: 435-781-4513		Fax: 435-781-4410	

**A COPY OF THESE CONDITIONS SHALL BE FURNISHED TO YOUR
FIELD REPRESENTATIVE TO INSURE COMPLIANCE**

All lease and/or unit operations are to be conducted in such a manner that full compliance is made with the applicable laws, regulations (43 CFR Part 3160), and this approved Application for Permit to Drill including Surface and Downhole Conditions of Approval. The operator is considered fully responsible for the actions of his subcontractors. A copy of the approved APD must be on location during construction, drilling, and completion operations. **This permit is approved for a one-year period. An additional year extension may be applied for by sundry notice prior to expiration.**

NOTIFICATION REQUIREMENTS

- | | |
|---|---|
| Location Construction
(Notify Paul Buhler) | - Forty-Eight (48) hours prior to construction of location and access roads. |
| Location Completion
(Notify Paul Buhler) | - Prior to moving on the drilling rig. |
| Spud Notice
(Notify Petroleum Engineer) | - Twenty-Four (24) hours prior to spudding the well. |
| Casing String & Cementing
(Notify Jamie Sparger) | - Twenty-Four (24) hours prior to running casing and cementing all casing strings |
| BOP & Related Equipment Tests
(Notify Jamie Sparger) | - Twenty-Four (24) hours prior to initiating pressure tests |
| First Production Notice
(Notify Petroleum Engineer) | - Within Five (5) business days after new well begins or production resumes after well has been off production for more than ninety (90) days |

***SURFACE USE PROGRAM
CONDITIONS OF APPROVAL (COAs)***

See APD for condition of approval

- Within 90 calendar days of the approval date for this Application for Permit to Drill (APD), the operator/lessee shall submit to the Authorized Officer (AO), on Sundry Notice Form 3160-5, an Interim Surface Reclamation Plan for surface disturbance on well pads, access roads, and pipelines. At a minimum, this will include the reshaping of the pad to the original contour to the extent possible; the respreading of the top soil up to the rig anchor points; and, the area reseeded using appropriate reclamation methods. The AO will provide written approval or concurrence within 30 calendar days of receipt. During interim management of the surface, use the following seed mix:
 - 9 lbs of Hycrest Crested Wheatgrass and 3 lbs of Kochia Prostrata.
- If paleontological materials are uncovered during construction, the operator is to immediately stop work, and contact the Authorized Officer (AO). A report will be prepared by the Paleontologist and submitted to the BLM at the completion of surface disturbing activities.
- All the culverts will be installed according to the BLM Gold Book. There will be 2 culverts on the access road along with 2 low water crossings
- The road and well pad will have road base on the surface.
- Bury pipeline at all low water crossings.
- Catchment pond will be built west of the pit. Use 18" culvert as spillway.
- Berm West side of location with at least a 2 foot berm.

DOWNHOLE CONDITIONS OF APPROVAL

All provisions outlined in Onshore Oil & Gas Order #2 Drilling Operations shall be strictly adhered to. The following items are emphasized:

SITE SPECIFIC DOWNHOLE CONDITIONS OF APPROVAL

- A surface casing shoe integrity test shall be performed.
- A variance is granted for Onshore Order #2-Drilling Operations III. E. "Blooie line discharge 100 feet from well bore and securely anchored."
 - Blooie line can be 75 feet.
- Production casing cement shall be at a minimum 200 feet inside the surface casing. A CBL shall be run from TD to top of cement and a field copy shall be sent to this field office.

DRILLING/COMPLETION/PRODUCING OPERATING STANDARDS

- There shall be no deviation from the proposed drilling, completion, and/or workover program as approved. Safe drilling and operating practices must be observed. All wells, whether drilling, producing, suspended, or abandoned, shall be identified in accordance with 43 CFR 3162.6. There shall be a sign or marker with the name of the operator, lease serial number, well number, and surveyed description of the well. Any changes in operation must have prior approval from the BLM, Vernal Field Office Petroleum Engineers.
- The spud date and time shall be reported orally to Vernal Field Office within 24 hours of spudding.
- Notify Vernal Field Office Supervisory Petroleum Engineering Technician at least 24 hours in advance of casing cementing operations and BOPE & casing pressure tests.
- Blowout prevention equipment (BOPE) shall remain in use until the well is completed or abandoned. Closing unit controls shall remain unobstructed and readily accessible at all times. Choke manifolds shall be located outside of the rig substructure.
- All BOPE components shall be inspected daily and those inspections shall be recorded in the daily drilling report. Components shall be operated and tested as required by Onshore Oil & Gas Order No. 2 to insure good mechanical working order. All BOPE pressure tests shall be performed by a test pump with a chart recorder and NOT by the rig pumps. Test shall be reported in the driller's log.
- BOP drills shall be initially conducted by each drilling crew within 24 hours of drilling out from under the surface casing and weekly thereafter as specified in Onshore Oil & Gas Order No. 2.
- Casing pressure tests are required before drilling out from under all casing strings set and cemented in place.
- No aggressive/fresh hard-banded drill pipe shall be used within casing.

- The lessee/operator must report all shows of water or water-bearing sands to the BLM. If flowing water is encountered it must be sampled and analyzed (a copy of the analyses to be submitted to the BLM Field Office in Vernal, Utah).
- All oil and gas shows shall be adequately tested for commercial possibilities, reported, and protected.
- The lessee/operator must report encounters of all non oil & gas mineral resources (such as Gilsonite, tar sands, oil shale, etc.) to Peter Sokolosky or another geologist of the Vernal Field Office, in writing, within 5 working days of each encounter. Each report shall include the well name/number, well location, date and depth (from KB or GL) of encounter, vertical footage of the encounter and, the name of the person making the report (along with a telephone number) shall the BLM need to obtain additional information.
- All shows of fresh water and minerals shall be reported and protected. A sample shall be taken of any water flows and a water analysis furnished the BLM, Vernal Field Office. All oil and gas shows shall be adequately tested for commercial possibilities, reported, and protected.
- No location shall be constructed or moved, no well shall be plugged, and no drilling or workover equipment shall be removed from a well to be placed in a suspended status without prior approval of the BLM, Vernal Field Office. If operations are to be suspended for more than 30 days, prior approval of the BLM, Vernal Field Office shall be obtained and notification given before resumption of operations.
- Chronologic drilling progress reports shall be filed directly with the BLM, Vernal Field Office on a weekly basis in sundry, letter format or e-mail to the Petroleum Engineers until the well is completed.
- Any change in the program shall be approved by the BLM, Vernal Field Office. "Sundry Notices and Reports on Wells" (Form BLM 3160-5) shall be filed for all changes of plans and other operations in accordance with 43 CFR 3162.3-2.
- Emergency approval may be obtained orally, but such approval does not waive the written report requirement. Any additional construction, reconstruction, or alterations of facilities, including roads, gathering lines, batteries, etc., which will result in the disturbance of new ground, shall require the filing of a suitable plan pursuant to Onshore Oil & Gas Order No. 1 of 43 CFR 3164.1 and prior approval by the BLM, Vernal Field Office.
- In accordance with 43 CFR 3162.4-3, this well shall be reported on the "Monthly Report of Operations" (Oil and Gas Operations Report ((OGOR)) starting with the month in which operations commence and continue each month until the well is physically plugged and abandoned. This report shall be filed in duplicate, directly with the Minerals Management Service, P.O. Box 17110, Denver, Colorado 80217-0110, or call 1-800-525-7922 (303) 231-3650 for reporting information.
- Whether the well is completed as a dry hole or as a producer, "Well Completion and Recompletion Report and Log" (BLM Form 3160-4) shall be submitted not later than 30 days after completion of the well or after completion of operations being performed, in

accordance with 43 CFR 3162.4-1. Two copies of all logs run, core descriptions, and all other surveys or data obtained and compiled during the drilling, workover, and/or completion operations, shall be filed on BLM Form 3160-4. Submit with the well completion report a geologic report including, at a minimum, formation tops, and a summary and conclusions. Also include deviation surveys, sample descriptions, strip logs, core data, drill stem test data, and results of production tests if performed. Samples (cuttings, fluid, and/or gas) shall be submitted only when requested by the BLM, Vernal Field Office.

- A cement bond log (CBL) will be run from the production casing shoe to the surface casing shoe and shall be utilized to determine the bond quality for the production casing. Submit a field copy of the CBL to this office.
- Please submit an electronic copy of all other logs run on this well in LAS format to UT_VN_Wellogs@BLM.gov. This submission will supersede the requirement for submittal of paper logs to the BLM.
- All off-lease storage, off-lease measurement, or commingling on-lease or off-lease shall have prior written approval from the BLM, Vernal Field Office.
- All measurement points shall be identified as point of sales or allocation for royalty determination prior to the installation of facilities.
- Oil and gas meters shall be calibrated in place prior to any deliveries. The Field Office Petroleum Engineers will be provided with a date and time for the initial meter calibration and all future meter proving schedules. A copy of the meter calibration reports shall be submitted to the BLM, Vernal Field Office. All measurement facilities will conform to the API standards for liquid hydrocarbons and the AGA standards for natural gas measurement.
- A schematic facilities diagram as required by Onshore Oil & Gas Order No. 3 shall be submitted to the BLM, Vernal Field Office within 30 days of installation or first production, whichever occurs first. All site security regulations as specified in Onshore Oil & Gas Order No. 3 shall be adhered to. All product lines entering and leaving hydrocarbon storage tanks will be effectively sealed in accordance with Onshore Oil & Gas Order No. 3.
- This APD is approved subject to the requirement that, shall the well be successfully completed for production, the BLM, Vernal Field office must be notified when it is placed in a producing status. Such notification will be by written communication and must be received in this office by not later than the fifth business day following the date on which the well is placed on production. The notification shall provide, as a minimum, the following informational items:
 - Operator name, address, and telephone number.
 - Well name and number.
 - Well location (¼¼, Sec., Twn, Rng, and P.M.).
 - Date well was placed in a producing status (date of first production for which royalty will be paid).
 - The nature of the well's production, (i.e., crude oil, or crude oil and casing head gas, or natural gas and entrained liquid hydrocarbons).
 - The Federal or Indian lease prefix and number on which the well is located;

- otherwise the non-Federal or non-Indian land category, i.e., State or private.
- Unit agreement and / or participating area name and number, if applicable.
 - Communitization agreement number, if applicable.
- Any venting or flaring of gas shall be done in accordance with Notice to Lessees (NTL) 4A and needs prior approval from Field Office Petroleum Engineers.
 - All undesirable events (fires, accidents, blowouts, spills, discharges) as specified in NTL 3A will be reported to the BLM, Vernal Field Office. Major events as defined in NTL3A, shall be reported verbally within 24 hours, followed by a written report within 15 days. "Other than Major Events" will be reported in writing within 15 days. "Minor Events" will be reported on the Monthly Report of Operations and Production.
 - Pursuant to Onshore Oil & Gas Order No. 7, this is authorization for pit disposal of water produced from this well for a period of 90 days from the date of initial production. A permanent disposal method must be approved by this office and in operation prior to the end of this 90-day period. In order to meet this deadline, an application for the proposed permanent disposal method shall be submitted along with any necessary water analyses, as soon as possible, but no later than 45 days after the date of first production. Any method of disposal which has not been approved prior to the end of the authorized 90-day period will be considered as an Incident of Noncompliance and will be grounds for issuing a shut-in order until an acceptable manner for disposing of said water is provided and approved by this office.
 - Unless the plugging is to take place immediately upon receipt of oral approval, the Field Office Petroleum Engineers must be notified at least 24 hours in advance of the plugging of the well, in order that a representative may witness plugging operations. If a well is suspended or abandoned, all pits must be fenced immediately until they are backfilled. The "Subsequent Report of Abandonment" (Form BLM 3160-5) must be submitted within 30 days after the actual plugging of the well bore, showing location of plugs, amount of cement in each, and amount of casing left in hole, and the current status of the surface restoration.

UNITED STATES
DEPARTMENT OF THE INTERIOR
BUREAU OF LAND MANAGEMENT

FORM APPROVED
OMB No. 1004-0137
Expires: March 31, 2007

SUNDRY NOTICES AND REPORTS ON WELLS

Do not use this form for proposals to drill or to re-enter an abandoned well. Use Form 3160-3 (APD) for such proposals.

SUBMIT IN TRIPLICATE- Other instructions on reverse side.

1. Type of Well ☐ Oil Well ☒ Gas Well ☐ Other

2. Name of Operator **EOG Resources, Inc.**

3a. Address
600 17th Street, Suite 1000N, Denver, CO 80202

3b. Phone No. (include area code)
303-824-5526

4. Location of Well (Footage, Sec., T., R., M., or Survey Description)
**2050' FSL & 480' FWL (NWSW, Lot 3)
Sec. 30-T8S-R23E 40.082106 LAT 109.377192 LON**

5. Lease Serial No.

UTU-61400

6. If Indian, Allottee or Tribe Name

7. If Unit or CA/Agreement, Name and/or No.

8. Well Name and No.

Hoss 32-30

9. API Well No.

43-047-38701

10. Field and Pool, or Exploratory Area

Natural Buttes/Wasatch/Mesaverde

11. County or Parish, State

Uintah County, UT


12. CHECK APPROPRIATE BOX(ES) TO INDICATE NATURE OF NOTICE, REPORT, OR OTHER DATA

TYPE OF SUBMISSION	TYPE OF ACTION			
<input checked="" type="checkbox"/> Notice of Intent	<input type="checkbox"/> Acidize	<input type="checkbox"/> Deepen	<input type="checkbox"/> Production (Start/Resume)	<input type="checkbox"/> Water Shut-Off
<input type="checkbox"/> Subsequent Report	<input type="checkbox"/> Alter Casing	<input type="checkbox"/> Fracture Treat	<input type="checkbox"/> Reclamation	<input type="checkbox"/> Well Integrity
<input type="checkbox"/> Final Abandonment Notice	<input type="checkbox"/> Casing Repair	<input type="checkbox"/> New Construction	<input type="checkbox"/> Recomplete	<input checked="" type="checkbox"/> Other Change location layout
	<input type="checkbox"/> Change Plans	<input type="checkbox"/> Plug and Abandon	<input type="checkbox"/> Temporarily Abandon	
	<input type="checkbox"/> Convert to Injection	<input type="checkbox"/> Plug Back	<input type="checkbox"/> Water Disposal	

13. Describe Proposed or Completed Operation (clearly state all pertinent details, including estimated starting date of any proposed work and approximate duration thereof. If the proposal is to deepen directionally or recompleat horizontally, give subsurface locations and measured and true vertical depths of all pertinent markers and zones. Attach the Bond under which the work will be performed or provide the Bond No. on file with BLM/BIA. Required subsequent reports must be filed within 30 days following completion of the involved operations. If the operation results in a multiple completion or recompleat in a new interval, a Form 3160-4 must be filed once testing has been completed. Final Abandonment Notices must be filed only after all requirements, including reclamation, have been completed, and the operator has determined that the site is ready for final inspection.)

As per verbal approval with Paul Buhler, BLM Vernal Field Office, EOG Resources, Inc. requests authorization to change the location layout, as per the attached revised plat, for the referenced well. The original location layout did not provide adequate surface disturbance to install rig anchors at distances as required by the manufacturer and API specifications.

**Accepted by the
Utah Division of
Oil, Gas and Mining
FOR RECORD ONLY**

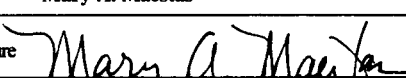14. I hereby certify that the foregoing is true and correct Name (Printed/Typed) Mary A. Maestas		Title Regulatory Assistant
Signature 		Date 04/23/2007

THIS SPACE FOR FEDERAL OR STATE OFFICE USE

Approved by _____	Title _____	Date _____
Conditions of approval, if any, are attached. Approval of this notice does not warrant or certify that the applicant holds legal or equitable title to those rights in the subject lease which would entitle the applicant to conduct operations thereon.	Office _____	

Title 18 U.S.C. Section 1001 and Title 43 U.S.C. Section 1212, make it a crime for any person knowingly and willfully to make to any department or agency of the United States any false, fictitious or fraudulent statements or representations as to any matter within its jurisdiction.

(Instructions on page 2)

RECEIVED

APR 24 2007

DIV. OF OIL, GAS & MINING

R
22
E

T8S, R23E, S.L.B.&M.

EOG RESOURCES, INC.


Well location, HOSS #32-30, located as shown in Lot 3 of Section 30, T8S, R23E, S.L.B.&M., Uintah County, Utah.

BASIS OF ELEVATION



BENCH MARK 20EAM LOCATED IN THE SE 1/4 OF SECTION 35, T8S, R21E, S.L.B.&M. TAKEN FROM THE OURAY SE, QUADRANGLE, UTAH, UTAH COUNTY, 7.5 MINUTE QUAD. (TOPOGRAPHIC MAP) PUBLISHED BY THE UNITED STATES DEPARTMENT OF THE INTERIOR, GEOLOGICAL SURVEY. SAID ELEVATION IS MARKED AS BEING 4697 FEET.

BASIS OF BEARINGS

BASIS OF BEARINGS IS A G.P.S. OBSERVATION.

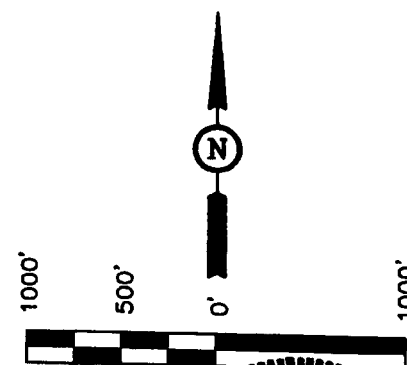

THIS IS TO CERTIFY THAT THE ABOVE PLAT WAS PREPARED FROM FIELD NOTES OF ACTUAL SURVEY MADE BY ME OR UNDER MY SUPERVISION AND THAT THE SAME ARE TRUE AND CORRECT TO THE BEST OF MY KNOWLEDGE AND BELIEF.

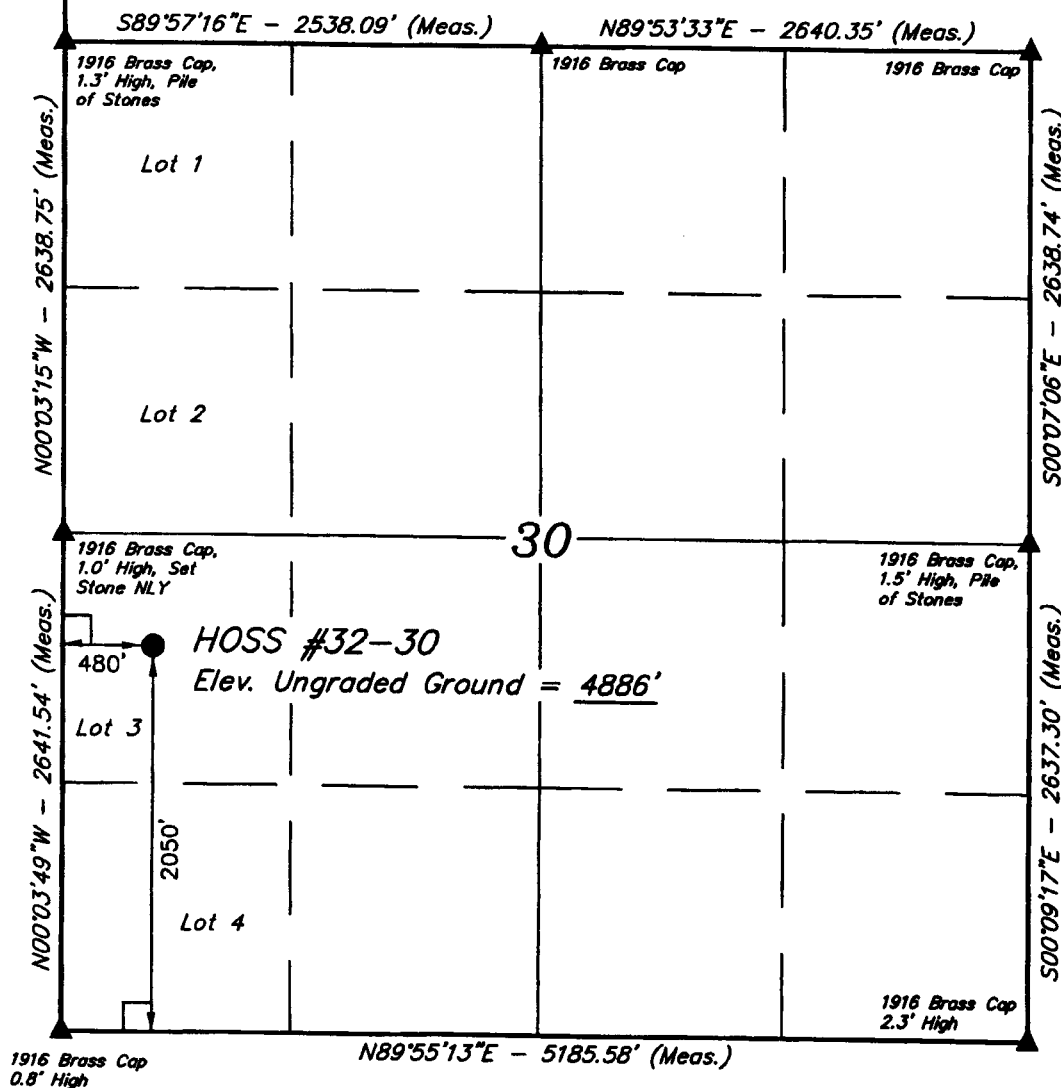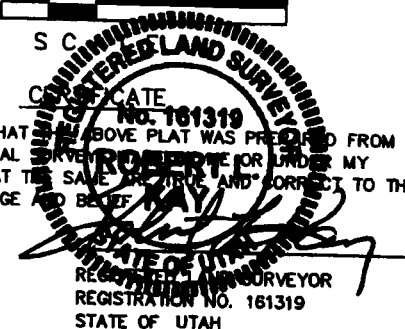

LEGEND:

- └─┘ = 90° SYMBOL
- = PROPOSED WELL HEAD.
- ▲ = SECTION CORNERS LOCATED.

(NAD 83)
 LATITUDE = 40°05'31.58" (40.082106)
 LONGITUDE = 109°22'37.89" (109.377192)
 (NAD 27)
 LATITUDE = 40°05'31.71" (40.092142)
 LONGITUDE = 109°22'35.43" (109.376508)

UINTAH ENGINEERING & LAND SURVEYING
 85 SOUTH 200 EAST - VERNAL, UTAH 84078
 (435) 789-1017

SCALE 1" = 1000'	DATE SURVEYED: 07-05-06	DATE DRAWN: 07-07-06
PARTY T.A. B.C. C.G.	REFERENCES G.L.O. PLAT	
WEATHER WARM	FILE EOG RESOURCES, INC.	

EOG RESOURCES, INC.

LOCATION LAYOUT FOR

HOSS #32-30


SECTION 30, T8S, R23E, S.L.B.&M.

2050' FSL 480' FWL

Proposed Access Road

F-1.6'
El. 84.8'

Sta. 3+25

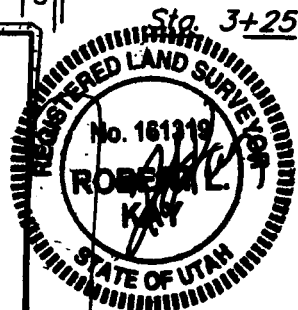

SCALE: 1" = 50'
DATE: 01-03-07
Drawn By: C.H.

Approx.
Top of
Cut Slope

NOTE:

Flare Pit is to be located
a min. of 100' from the
Well Head.

NOTE:
Earthwork Calculations Require
a Fill of 0.8' @ the Location
Stake For Balance. All Fill is
to be Compacted to a Minimum
of 95% of the Maximum Dry
Density Obtained by AASHTO
Method t-99.

Pit Topsoil

C-2.1'
El. 88.5'

F-0.8'
El. 85.6'

Sta. 1+50

F-2.5'
El. 83.9'

Sta. 0+00

El. 89.6'
C-15.2'
(btm. pit)

Reserve Pit Backfill
& Spoils Stockpile

15' WIDE BENCH

Total Pit Capacity
W/2' Of Freeboard
= 12,250 Bbls. ±
Total Pit Volume
= 3,320 Cu. Yds.
RESERVE PITS
(12' Deep)
SLOPE = 1-1/2 : 1

20' WIDE BENCH

El. 88.8'
C-14.4'
(btm. pit)

C-1.1'
El. 87.5'

C-0.4'
El. 86.8'

Existing
Drainage

F-4.0'
El. 82.4'

NOTES:

Elev. Ungraded Ground At Loc. Stake = 4885.6'

FINISHED GRADE ELEV. AT LOC. STAKE = 4886.4'

FIGURE #1

UINTAH ENGINEERING & LAND SURVEYING
85 So. 200 East • Vernal, Utah 84078 • (435) 789-1017

EOG RESOURCES, INC.

TYPICAL CROSS SECTIONS FOR


HOSS #32-30

SECTION 30, T8S, R23E, S.L.B.&M.

2050' FSL 480' FWL

FIGURE #2

1" = 20'
X-Section
Scale
1" = 50'
DATE: 01-03-07
Drawn By: C.H.

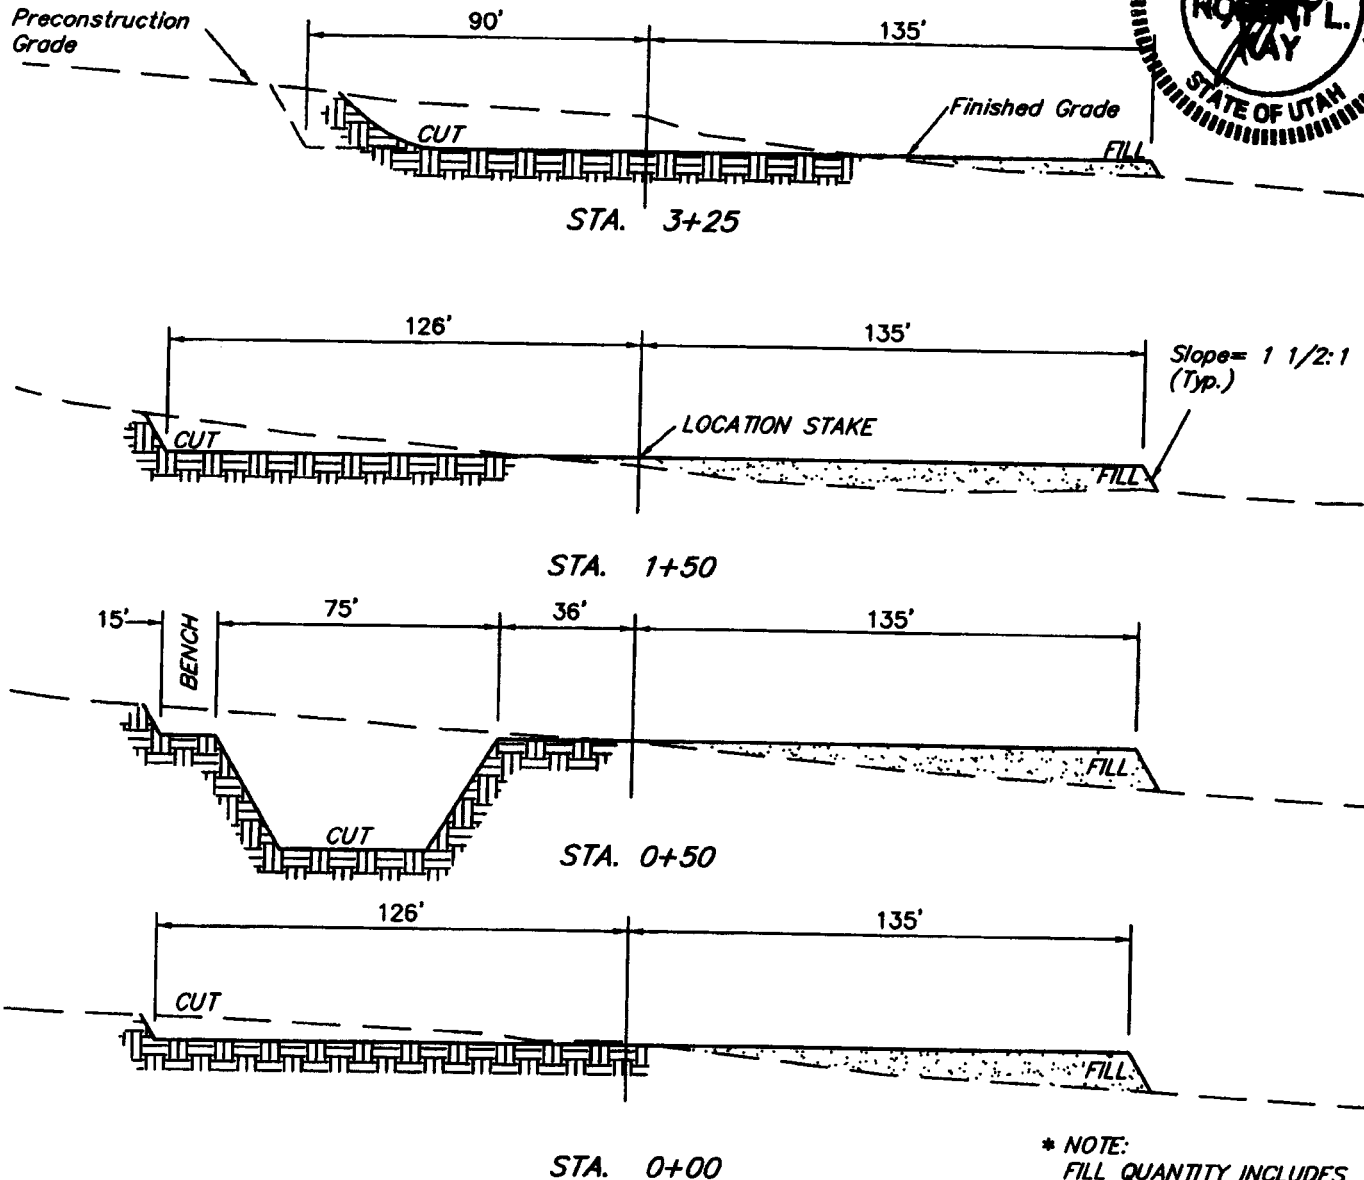

* NOTE:
FILL QUANTITY INCLUDES
5% FOR COMPACTION

APPROXIMATE YARDAGES

CUT	
(6") Topsoil Stripping	= 1,630 Cu. Yds.
Remaining Location	= 5,270 Cu. Yds.
TOTAL CUT	= 6,900 CU.YDS.
FILL	= 3,610 CU.YDS.

EXCESS MATERIAL	= 3,290 Cu. Yds.
Topsoil & Pit Backfill (1/2 Pit Vol.)	= 3,290 Cu. Yds.
EXCESS UNBALANCE (After Interim Rehabilitation)	= 0 Cu. Yds.

UINTAH ENGINEERING & LAND SURVEYING
85 So. 200 East • Vernal, Utah 84078 • (435) 789-1017


EOG RESOURCES, INC.

PRODUCTION FACILITY LAYOUT FOR

HOSS #32-30

SECTION 30, T8S, R23E, S.L.B.&M.



2050' FSL 480' FWL

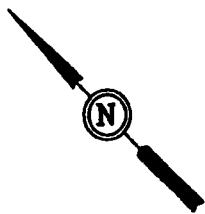

SCALE: 1" = 50'

DATE: 01-03-07

Drawn By: C.H.

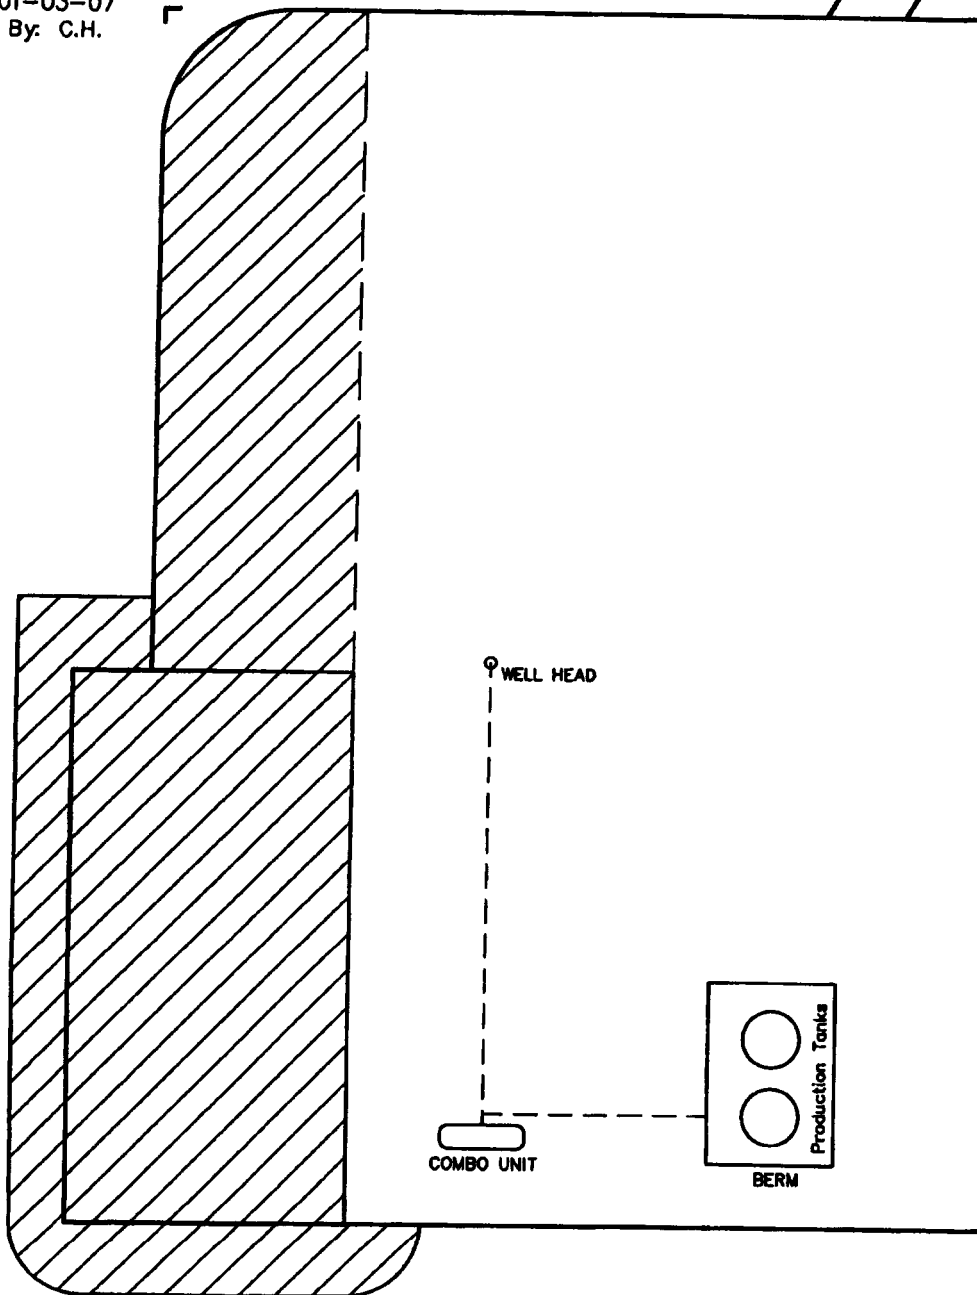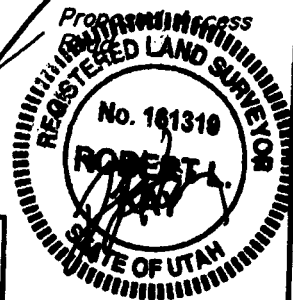

RE-HABED AREA

EOG RESOURCES, INC.

HOSS #32-30

LOCATED IN UINTAH COUNTY, UTAH
SECTION 30, T8S, R23E, S.L.B.&M.

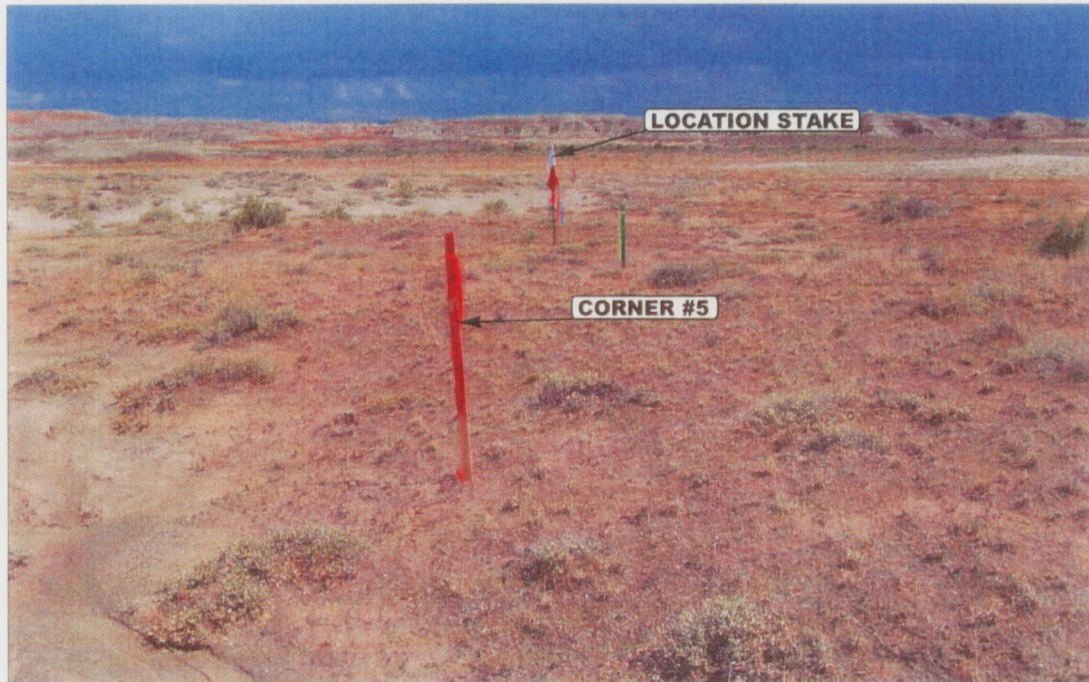


PHOTO: VIEW FROM CORNER #5 TO LOCATION STAKE

CAMERA ANGLE: SOUTHEASTERLY



PHOTO: VIEW FROM BEGINNING OF PROPOSED ACCESS

CAMERA ANGLE: NORTHWESTERLY



Since 1964

UELS Uintah Engineering & Land Surveying
85 South 200 East Vernal, Utah 84078
435-789-1017 uels@uelsinc.com

LOCATION PHOTOS


07 06 06
MONTH DAY YEAR

PHOTO

TAKEN BY: T.A.

DRAWN BY: C.P.

REVISED: 00-00-00

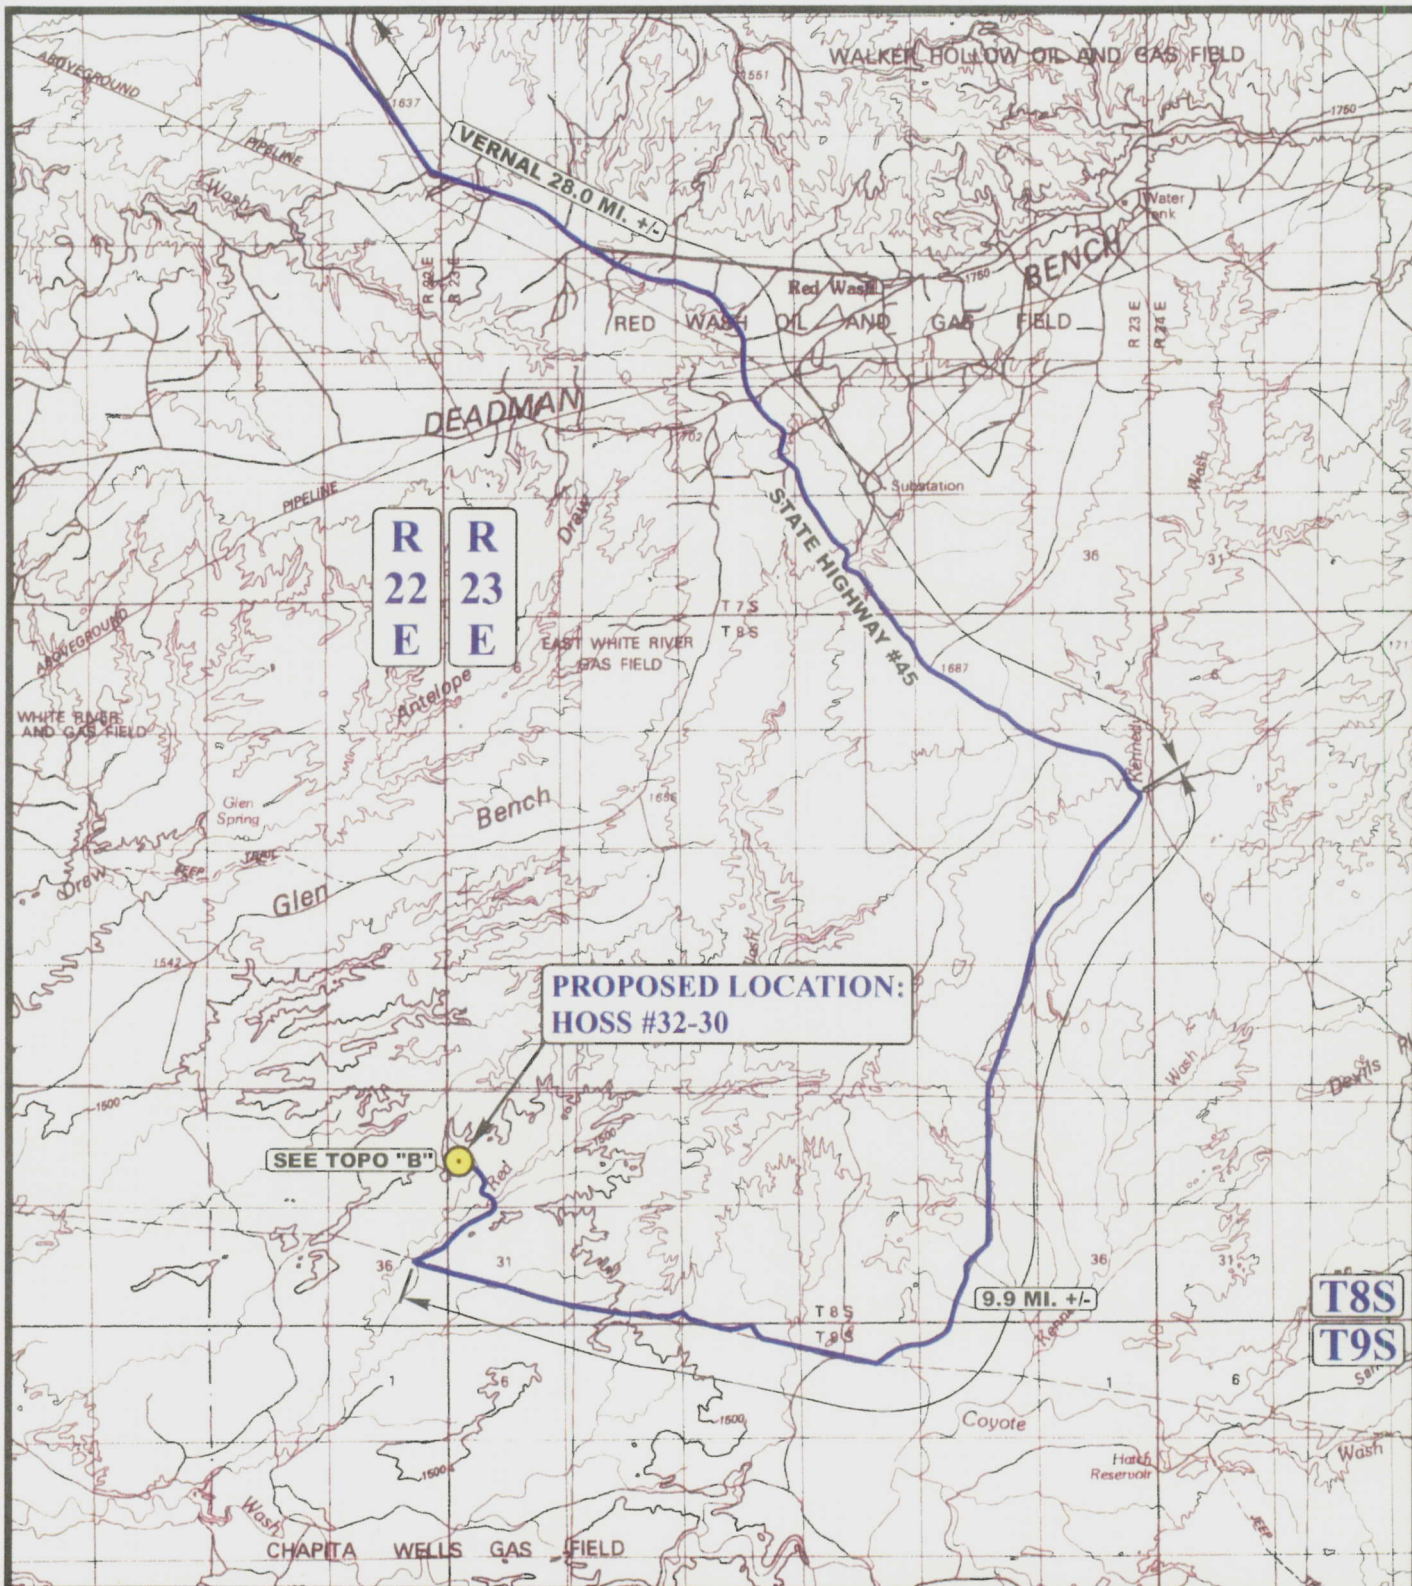

LEGEND:

 **PROPOSED LOCATION**

EOG RESOURCES, INC.

HOSS #32-30
SECTION 30, T8S, R23E, S.L.B.&M.
2050' FSL 480' FWL




Utah Engineering & Land Surveying
 85 South 200 East Vernal, Utah 84078
 (435) 789-1017 * FAX (435) 789-1813

TOPOGRAPHIC
MAP

07 06 06
 MONTH DAY YEAR

SCALE: 1:100,000 DRAWN BY: C.P. REVISED: 00-00-00



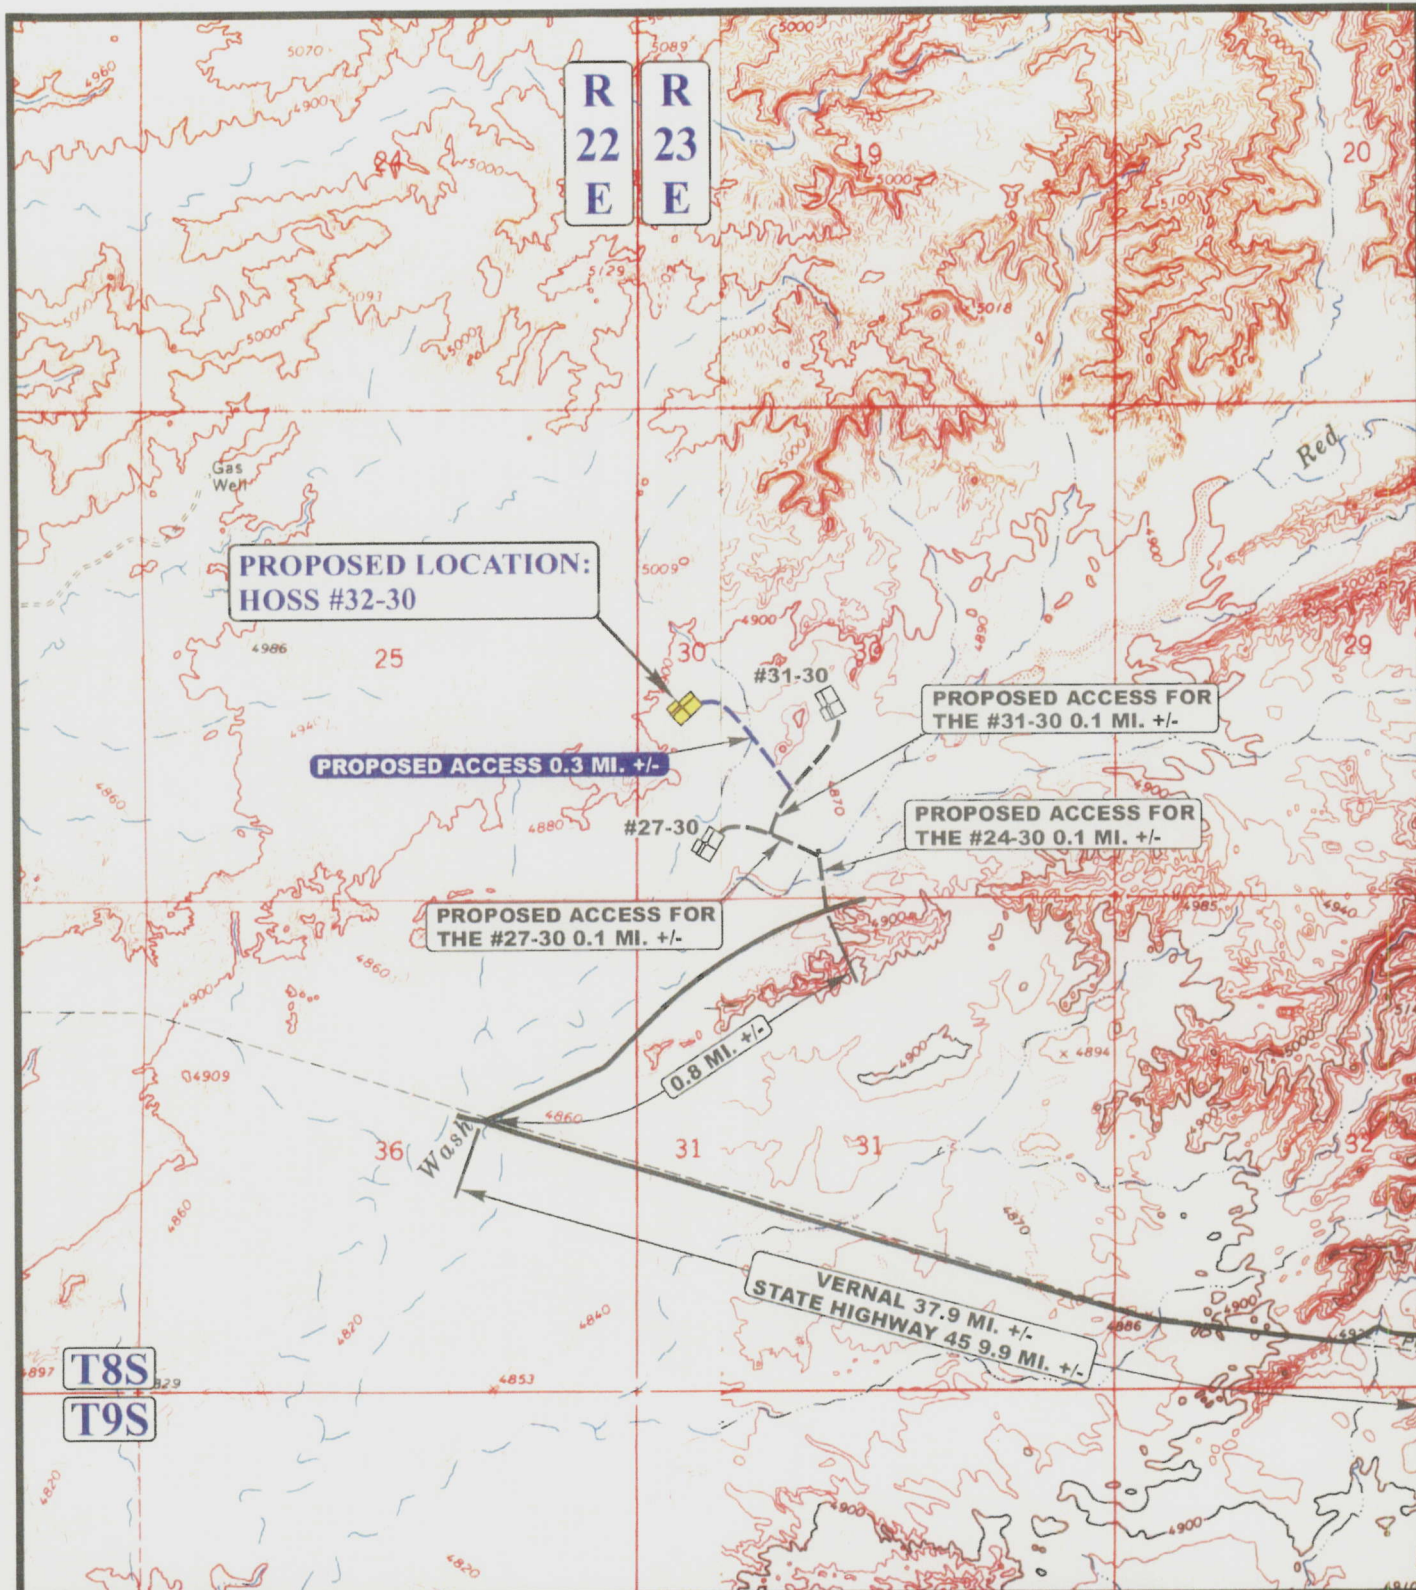

LEGEND:

EXISTING ROAD
 PROPOSED ACCESS ROAD

EOG RESOURCES, INC.

HOSS #32-30
SECTION 30, T8S, R23E, S.L.B.&M.
2050' FSL 480' FWL



Uintah Engineering & Land Surveying
85 South 200 East Vernal, Utah 84078
(435) 789-1017 * FAX (435) 789-1813




TOPOGRAPHIC
MAP

07 06 06
MONTH DAY YEAR

SCALE: 1" = 2000' DRAWN BY: C.P. REVISED: 00-00-00

B
TOPO

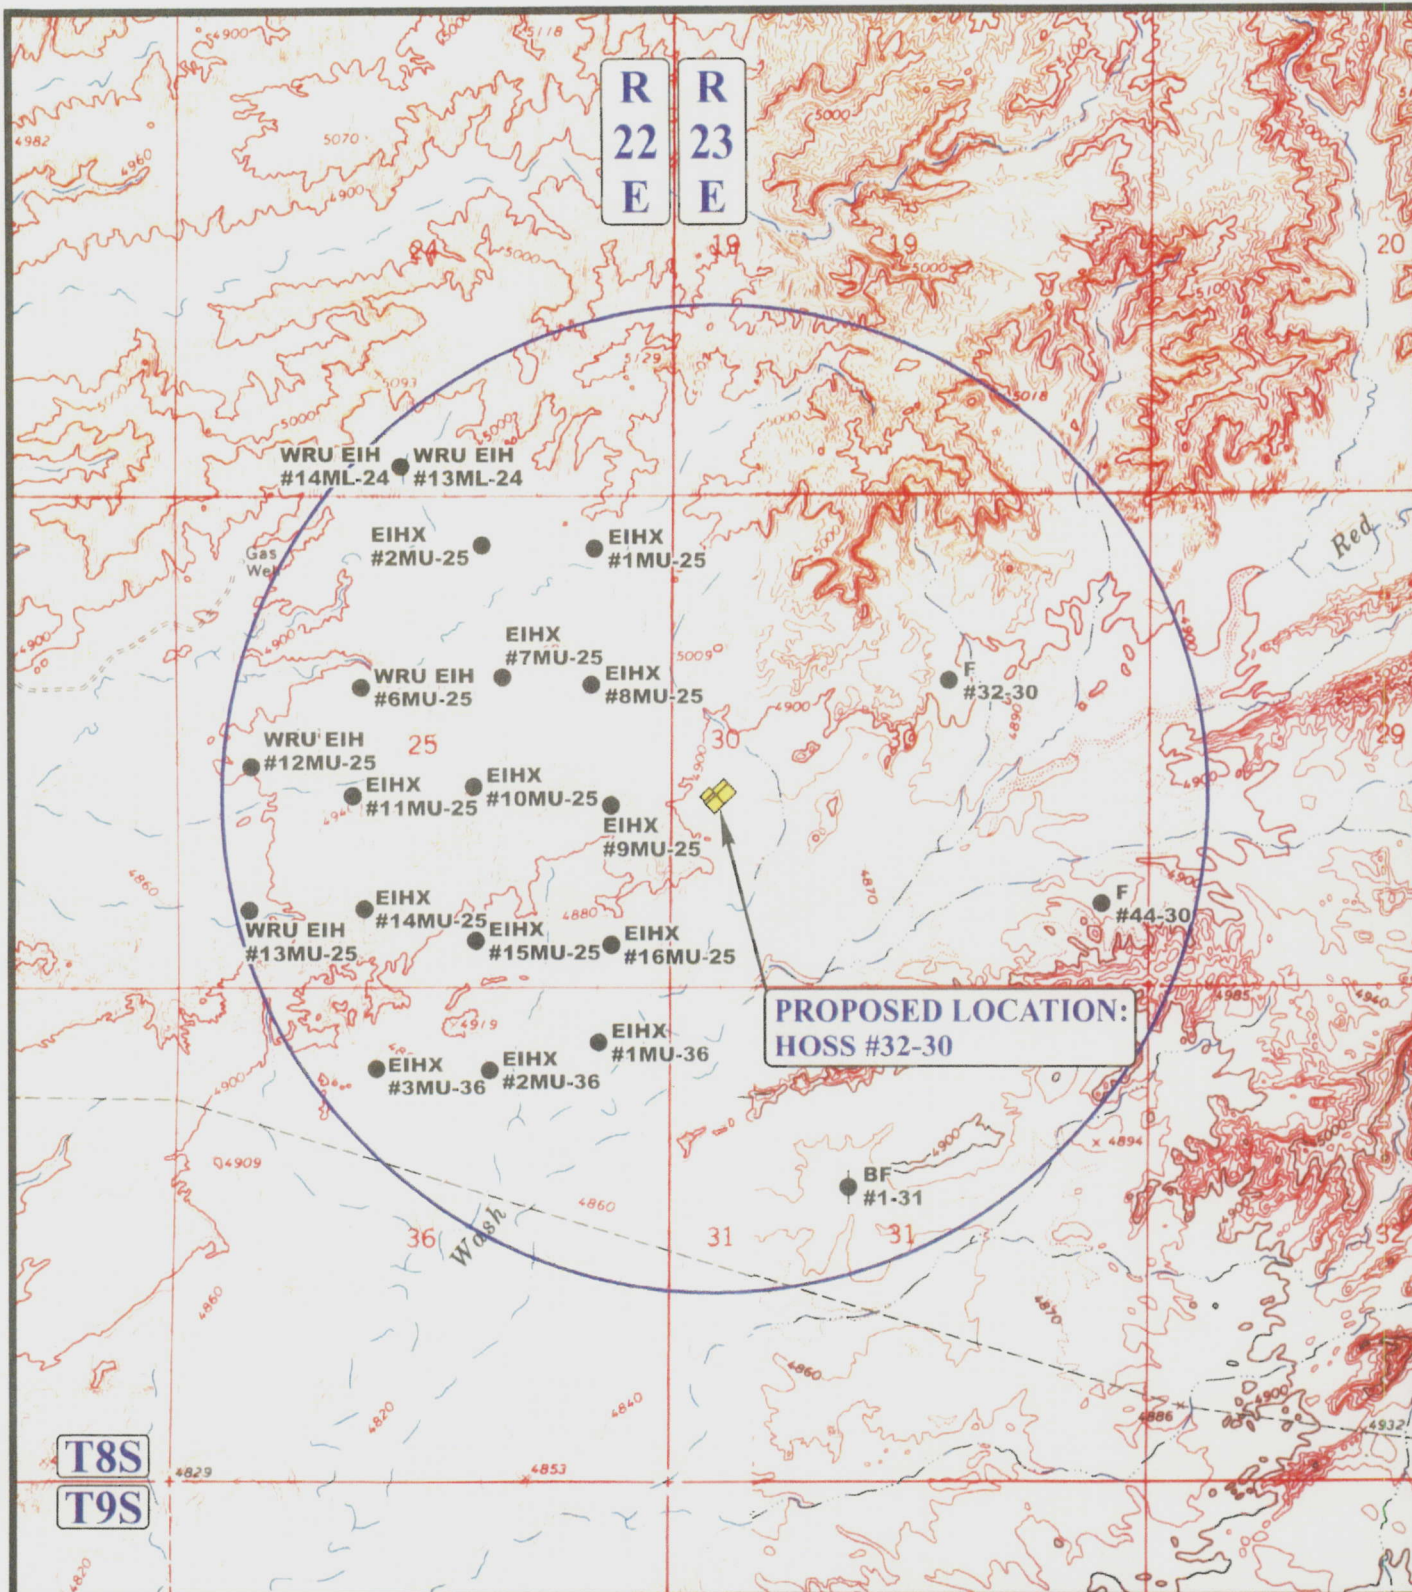

LEGEND:

- DISPOSAL WELLS
- PRODUCING WELLS
- SHUT IN WELLS
- WATER WELLS
- ABANDONED WELLS
- TEMPORARILY ABANDONED



Uintah Engineering & Land Surveying
 85 South 200 East Vernal, Utah 84078
 (435) 789-1017 * FAX (435) 789-1813



EOG RESOURCES, INC.

HOSS #32-30
SECTION 30, T8S, R23E, S.L.B.&M.
2050' FSL 480' FWL

TOPOGRAPHIC
MAP


07 06 06
 MONTH DAY YEAR

SCALE: 1" = 2000'

DRAWN BY: C.P.

REVISED: 00-00-00



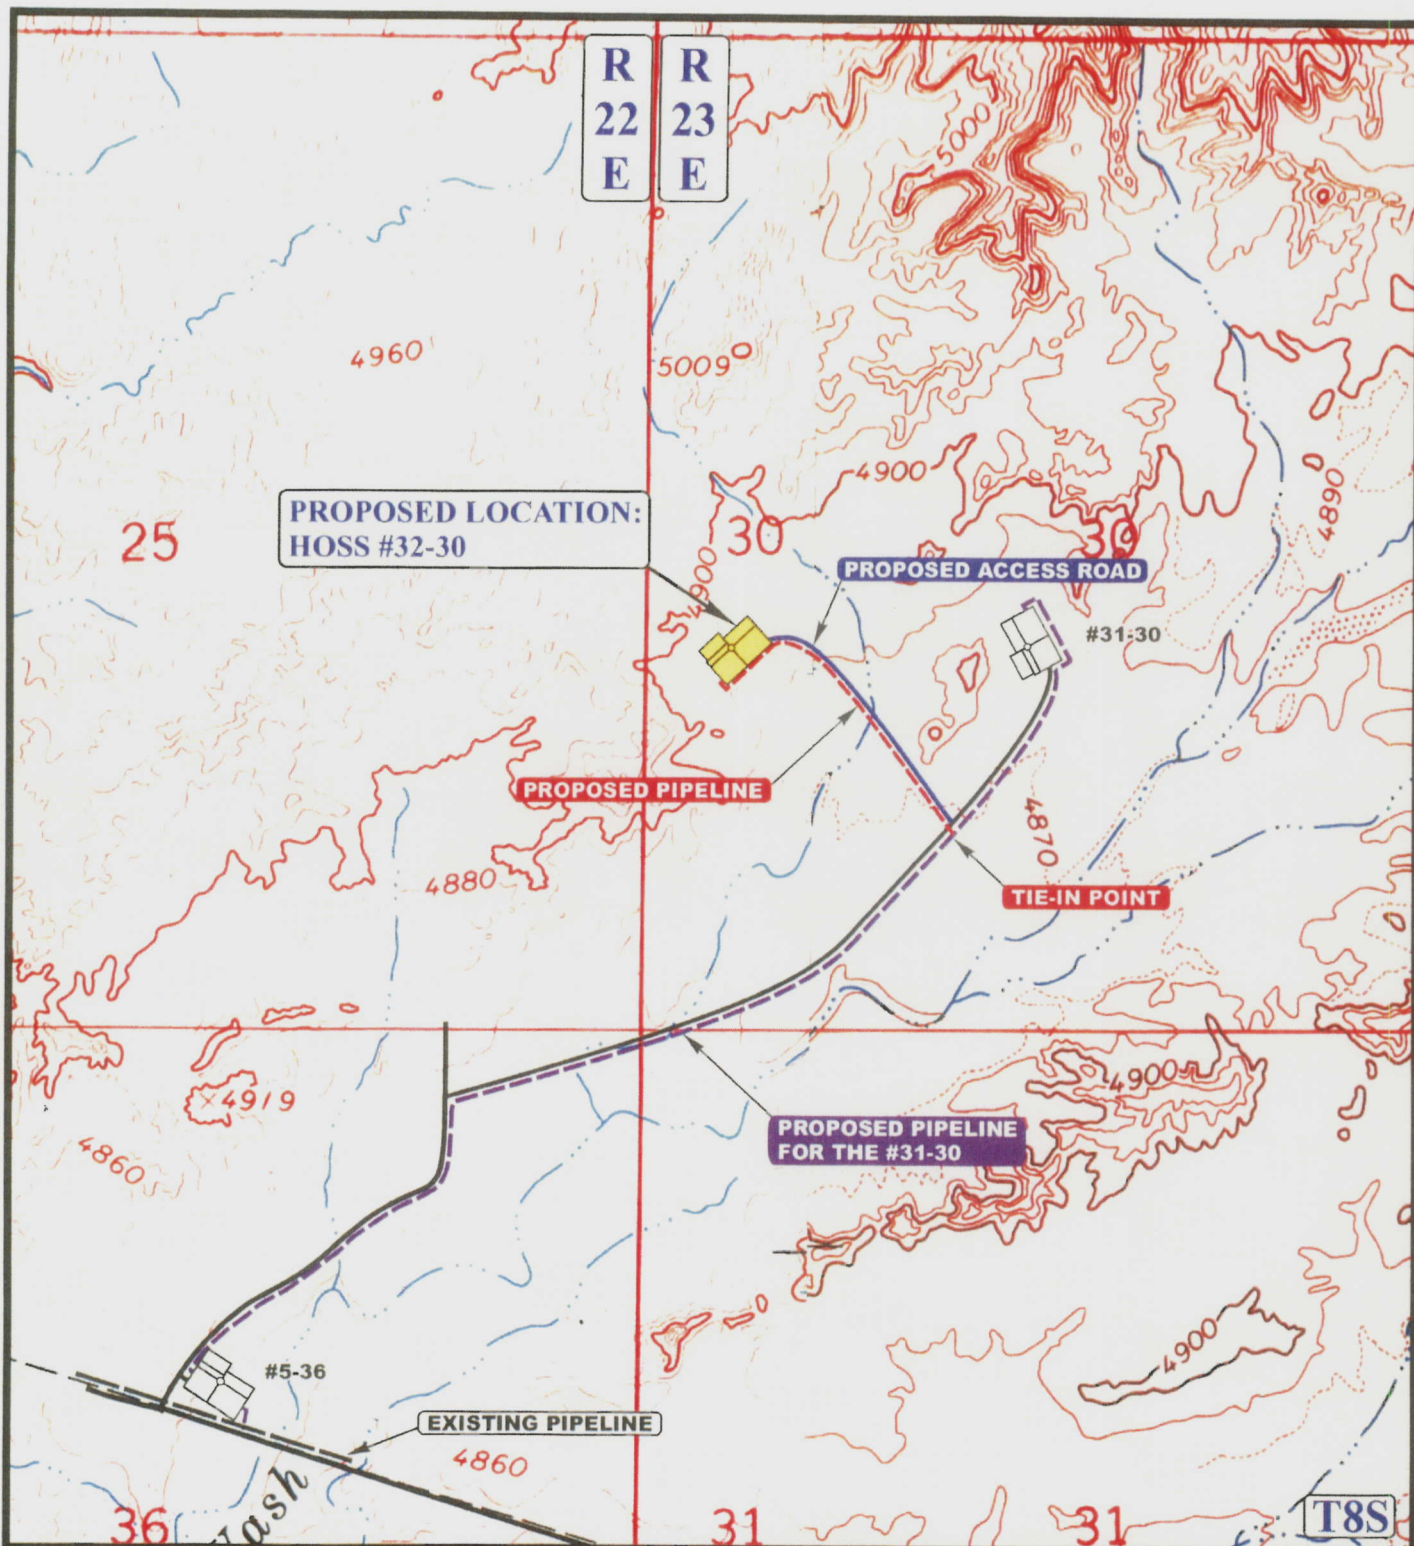

APPROXIMATE TOTAL PIPELINE DISTANCE = 1860' +/-

LEGEND:

- PROPOSED ACCESS ROAD
- EXISTING PIPELINE
- - - - - PROPOSED PIPELINE
- - - - - PROPOSED PIPELINE
(SERVICING OTHER WELLS)

EOG RESOURCES, INC.

HOSS #32-30

SECTION 30, T8S, R23E, S.L.B.&M.

2050' FSL 480' FWL



Uintah Engineering & Land Surveying
85 South 200 East Vernal, Utah 84078
(435) 789-1017 * FAX (435) 789-1813



**TOPOGRAPHIC
MAP**

09 13 06
MONTH DAY YEAR

SCALE: 1" = 1000' DRAWN BY: C.H. REVISED: 00-00-00

D
TOPO

DIVISION OF OIL, GAS AND MINING

SPUDDING INFORMATION

Name of Company: EOG Resources, Inc

Well Name: Hoss 32-30

API No: 43-047-38701 Lease Type: Federal

Section 30 Township 08S Range 23E County Uintah

Drilling Contractor Rocky Mountain Drilling Rig # Bucket

SPUDDED:

Date 6-12-07

Time 1:30 PM

How Dry

Drilling will Commence: _____

Reported by Dale Cook

Telephone # 435-828-3630

Date 6-13-07 Signed RM

STATE OF UTAH
DEPARTMENT OF NATURAL RESOURCES
DIVISION OF OIL, GAS AND MINING

FORM 6

ENTITY ACTION FORM

Operator: EOG RESOURCES, INC. Operator Account Number: N 9550
Address: 600 17th Street
city Denver
state CO zip 80202 Phone Number: (303) 262-2812

Well 1

API Number	Well Name		QQ	Sec	Twp	Rng	County
43-047-36279	NATURAL BUTTES UNIT 451-1E		NESW	1	10S	22E	UINTAH
Action Code	Current Entity Number	New Entity Number	Spud Date			Entity Assignment Effective Date	
<i>AB</i>	99999	<i>2900</i>	6/12/2007			<i>6/21/07</i>	
Comments: <i>PRRU = MVRD = WSTMVD</i>							

Well 2

API Number	Well Name		QQ	Sec	Twp	Rng	County
43-047-38709	HOSS 37-30		NWNE	30	8S	23E	UINTAH
Action Code	Current Entity Number	New Entity Number	Spud Date			Entity Assignment Effective Date	
<i>A</i>	99999	<i>16189</i>	6/12/2007			<i>6/21/07</i>	
Comments: <i>PRRU = MVRD</i>							

Well 3

API Number	Well Name		QQ	Sec	Twp	Rng	County
43-047-38701	HOSS 32-30		NWSW	30	8S	23E	UINTAH
Action Code	Current Entity Number	New Entity Number	Spud Date			Entity Assignment Effective Date	
<i>A</i>	99999	<i>16190</i>	6/12/2007			<i>6/21/07</i>	
Comments: <i>PRRU = MVRD</i>							

ACTION CODES:

- A - Establish new entity for new well (single well only)
- B - Add new well to existing entity (group or unit well)
- C - Re-assign well from one existing entity to another existing entity
- D - Re-assign well from one existing entity to a new entity
- E - Other (Explain in 'comments' section)

Carrie MacDonald

Name (Please Print)

Signature

Operations Clerk

Title

6/19/2007

Date

RECEIVED

JUN 21 2007

UNITED STATES
DEPARTMENT OF THE INTERIOR
BUREAU OF LAND MANAGEMENT

FORM APPROVED
OMB No. 1004-0137
Expires: March 31, 2007

SUNDRY NOTICES AND REPORTS ON WELLS

Do not use this form for proposals to drill or to re-enter an abandoned well. Use Form 3160-3 (APD) for such proposals.

SUBMIT IN TRIPLICATE- Other instructions on reverse side.

1. Type of Well
☐ Oil Well ☒ Gas Well ☐ Other

2. Name of Operator **EOG Resources, Inc.**

3a. Address
600 17th Street, Suite 1000N, Denver, CO 80202

3b. Phone No. (include area code)
303-262-2812

4. Location of Well (Footage, Sec., T., R., M., or Survey Description)
**2,050' FSL & 480' FWL (NWSW)
Sec. 30-T8S-R23E 40.082106 LAT 109.377192 LON**

5. Lease Serial No.
UTU-61400

6. If Indian, Allottee or Tribe Name

7. If Unit or CA/Agreement, Name and/or No.

8. Well Name and No.
Hoss 32-30

9. API Well No.
43-047-38701

10. Field and Pool, or Exploratory Area
Natural Buttes/Wasatch/Mesaverde

11. County or Parish, State
Uintah County, Utah

12. CHECK APPROPRIATE BOX(ES) TO INDICATE NATURE OF NOTICE, REPORT, OR OTHER DATA

TYPE OF SUBMISSION	TYPE OF ACTION			
<input type="checkbox"/> Notice of Intent	<input type="checkbox"/> Acidize	<input type="checkbox"/> Deepen	<input type="checkbox"/> Production (Start/Resume)	<input type="checkbox"/> Water Shut-Off
<input checked="" type="checkbox"/> Subsequent Report	<input type="checkbox"/> Alter Casing	<input type="checkbox"/> Fracture Treat	<input type="checkbox"/> Reclamation	<input type="checkbox"/> Well Integrity
<input type="checkbox"/> Final Abandonment Notice	<input type="checkbox"/> Casing Repair	<input type="checkbox"/> New Construction	<input type="checkbox"/> Recomplete	<input checked="" type="checkbox"/> Other Well spud
	<input type="checkbox"/> Change Plans	<input type="checkbox"/> Plug and Abandon	<input type="checkbox"/> Temporarily Abandon	
	<input type="checkbox"/> Convert to Injection	<input type="checkbox"/> Plug Back	<input type="checkbox"/> Water Disposal	

13. Describe Proposed or Completed Operation (clearly state all pertinent details, including estimated starting date of any proposed work and approximate duration thereof. If the proposal is to deepen directionally or recompleat horizontally, give subsurface locations and measured and true vertical depths of all pertinent markers and zones. Attach the Bond under which the work will be performed or provide the Bond No. on file with BLM/BIA. Required subsequent reports must be filed within 30 days following completion of the involved operations. If the operation results in a multiple completion or recompleat in a new interval, a Form 3160-4 must be filed once testing has been completed. Final Abandonment Notices must be filed only after all requirements, including reclamation, have been completed, and the operator has determined that the site is ready for final inspection.)

The referenced well spud on 6/12/2007.

RECEIVED

JUN 21 2007


DIV. OF OIL, GAS & MINING

14. I hereby certify that the foregoing is true and correct
Name (Printed/Typed)

Carrie MacDonald

Title **Operations Clerk**

Signature

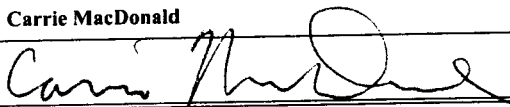

Date

06/19/2007

THIS SPACE FOR FEDERAL OR STATE OFFICE USE

Approved by

Conditions of approval, if any, are attached. Approval of this notice does not warrant or certify that the applicant holds legal or equitable title to those rights in the subject lease which would entitle the applicant to conduct operations thereon.

Title

Date

Office

Title 18 U.S.C. Section 1001 and Title 43 U.S.C. Section 1212, make it a crime for any person knowingly and willfully to make to any department or agency of the United States any false, fictitious or fraudulent statements or representations as to any matter within its jurisdiction.

(Instructions on page 2)

UNITED STATES
DEPARTMENT OF THE INTERIOR
BUREAU OF LAND MANAGEMENT

FORM APPROVED
OMB No. 1004-0137
Expires: March 31, 2007

SUNDRY NOTICES AND REPORTS ON WELLS

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1. Type of Well
☐ Oil Well ☒ Gas Well ☐ Other

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600 17th Street, Suite 1000N, Denver, CO 80202

3b. Phone No. (include area code)
303-262-2812

4. Location of Well (Footage, Sec., T., R., M., or Survey Description)
**2,050' FSL & 480' FWL (NWSW)
Sec. 30-T8S-R23E 40.082106 LAT 109.377192 LON**

5. Lease Serial No.
UTU-61400

6. If Indian, Allottee or Tribe Name

7. If Unit or CA/Agreement, Name and/or No.

8. Well Name and No.
Hoss 32-30

9. API Well No.
43-047-38701

10. Field and Pool, or Exploratory Area
Natural Buttes/Wasatch/Mesaverde

11. County or Parish, State
Uintah County, Utah

12. CHECK APPROPRIATE BOX(ES) TO INDICATE NATURE OF NOTICE, REPORT, OR OTHER DATA

TYPE OF SUBMISSION	TYPE OF ACTION			
<input checked="" type="checkbox"/> Notice of Intent	<input type="checkbox"/> Acidize	<input type="checkbox"/> Deepen	<input type="checkbox"/> Production (Start/Resume)	<input type="checkbox"/> Water Shut-Off
<input type="checkbox"/> Subsequent Report	<input type="checkbox"/> Alter Casing	<input type="checkbox"/> Fracture Treat	<input type="checkbox"/> Reclamation	<input type="checkbox"/> Well Integrity
<input type="checkbox"/> Final Abandonment Notice	<input type="checkbox"/> Casing Repair	<input type="checkbox"/> New Construction	<input type="checkbox"/> Recomplete	<input type="checkbox"/> Other
	<input type="checkbox"/> Change Plans	<input type="checkbox"/> Plug and Abandon	<input type="checkbox"/> Temporarily Abandon	
	<input type="checkbox"/> Convert to Injection	<input type="checkbox"/> Plug Back	<input checked="" type="checkbox"/> Water Disposal	

13. Describe Proposed or Completed Operation (clearly state all pertinent details, including estimated starting date of any proposed work and approximate duration thereof. If the proposal is to deepen directionally or recompleat horizontally, give subsurface locations and measured and true vertical depths of all pertinent markers and zones. Attach the Bond under which the work will be performed or provide the Bond No. on file with BLM/BIA. Required subsequent reports must be filed within 30 days following completion of the involved operations. If the operation results in a multiple completion or recompleat in a new interval, a Form 3160-4 must be filed once testing has been completed. Final Abandonment Notices must be filed only after all requirements, including reclamation, have been completed, and the operator has determined that the site is ready for final inspection.)

EOG Resources, Inc. requests authorization for disposal of produced water from the referenced well to any of the following locations.

- 1. Natural Buttes Unit 21-20B SWD**
- 2. Chapita Wells Unit 550-30N SWD**
- 3. Ace Disposal**
- 4. RN Industries**

Accepted by the
Division of
Oil, Gas and Mining
FOR RECORD ONLY

RECEIVED
JUN 21 2007


DIV. OF OIL, GAS & MINING

14. I hereby certify that the foregoing is true and correct
Name (Printed/Typed)

Carrie MacDonald

Title **Operations Clerk**

Signature

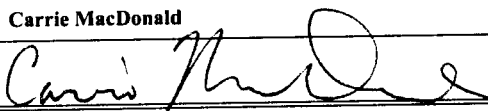

Date

06/19/2007

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Approved by

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Title

Date

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(Instructions on page 2)

Well:		API Number:	Commenced:
Ashley Fed 2	drlg rpts/wcr	4301332595	08/10/2006
CWU 1008-22	drlg rpts/wcr	4304736919	05/22/2007
Hoss 32-30	drlg rpts/wcr	4304738701	06/12/2007
Hoss 37-30	drlg rpts/wcr	4304738709	06/12/2007
NBU 546-1E	wcr	4304736280	06/15/2007
CWU 1225-11	drlg rpts/wcr	4304738426	06/18/2007
Gilsonite 11-02GR	wcr	4301333483	06/21/2007
CWU 1005-27	drlg rpts/wcr	4304736922	06/27/2007
CWU 1226-11	drlg rpts/wcr	4304738430	07/03/2007
Petes Wash U 13-06GR	drlg rpts/wcr	4301333203	07/06/2007
NBU 557-18E	drlg rpts/wcr	4304737513	07/07/2007
Hoss 38-30	drlg rpts/wcr	4304738708	07/11/2007
CWU 686-30	drlg rpts/wcr	4304736960	07/15/2007
N Chapita 340-34	drlg rpts/wcr	4304738060	07/24/2007

NOTICE

Utah Oil and Gas Conservation General Rule R649-3-21 states that,

- A well is considered completed when the well has been adequately worked to be capable of producing oil or gas or when well testing as required by the division is concluded.
- Within 30 days after the completion or plugging of a well, the following shall be filed:
 - Form 8, Well Completion or Recompletion Report and Log
 - A copy of electric and radioactivity logs, if run
 - A copy of drillstem test reports,
 - A copy of formation water analyses, porosity, permeability or fluid saturation determinations
 - A copy of core analyses, and lithologic logs or sample descriptions if compiled
 - A copy of directional, deviation, and/or measurement-while-drilling survey for each horizontal well

Failure to submit reports in a timely manner will result in the issuance of a Notice of Violation by the Division of Oil, Gas and Mining, and may result in the Division pursuing enforcement action as outlined in Rule R649-10, Administrative Procedures, and Section 40-6-11 of the Utah Code.

As of the mailing of this notice, the division has not received the required reports for

Operator: EOG Resources, Inc

Today's Date: 11/27/2007

Well:

API Number:

Drilling Commenced:

See Attachment

To avoid compliance action, required reports should be mailed within 7 business days to:

Utah Division of Oil, Gas and Mining
1594 West North Temple, Suite 1210
P.O. Box 145801
Salt Lake City, Utah 84114-5801

If you have questions or concerns regarding this matter, please call (801) 538-5284.

cc: Well File
Compliance File

UNITED STATES
DEPARTMENT OF THE INTERIOR
BUREAU OF LAND MANAGEMENT

FORM APPROVED
OMB No. 1004-0137
Expires: July 31, 2010

SUNDRY NOTICES AND REPORTS ON WELLS
**Do not use this form for proposals to drill or to re-enter an
abandoned well. Use Form 3160-3 (APD) for such proposals.**

5. Lease Serial No.
U-61400

6. If Indian, Allottee or Tribe Name

SUBMIT IN TRIPLICATE – Other instructions on page 2.

7. If Unit of CA/Agreement, Name and/or No.

1. Type of Well

☐ Oil Well ☒ Gas Well ☐ Other

8. Well Name and No.
Hoss 32-30

2. Name of Operator
EOG Resources, Inc.

9. API Well No.
43-047-38701

3a. Address
600 17th Street, Suite 1000N
Denver, CO 80202

3b. Phone No. (include area code)
303-824-5526

10. Field and Pool or Exploratory Area
Natural Buttes/Wasatch/Mesaverde

4. Location of Well (Footage, Sec., T., R., M., or Survey Description)
2050' FSL & 480' FWL (NWSW) Lot 3
Sec. 30-T8S-R23E 40.082106 LAT 109.377192 LON

11. Country or Parish, State
Uintah County, Utah

12. CHECK THE APPROPRIATE BOX(ES) TO INDICATE NATURE OF NOTICE, REPORT OR OTHER DATA

TYPE OF SUBMISSION	TYPE OF ACTION			
<input type="checkbox"/> Notice of Intent	<input type="checkbox"/> Acidize	<input type="checkbox"/> Deepen	<input type="checkbox"/> Production (Start/Resume)	<input type="checkbox"/> Water Shut-Off
<input checked="" type="checkbox"/> Subsequent Report	<input type="checkbox"/> Alter Casing	<input type="checkbox"/> Fracture Treat	<input type="checkbox"/> Reclamation	<input type="checkbox"/> Well Integrity
<input type="checkbox"/> Final Abandonment Notice	<input type="checkbox"/> Casing Repair	<input type="checkbox"/> New Construction	<input type="checkbox"/> Recomplete	<input checked="" type="checkbox"/> Other <u>Drilling operations</u>
	<input type="checkbox"/> Change Plans	<input type="checkbox"/> Plug and Abandon	<input type="checkbox"/> Temporarily Abandon	
	<input type="checkbox"/> Convert to Injection	<input type="checkbox"/> Plug Back	<input type="checkbox"/> Water Disposal	

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The referenced well reached TD on 11/15/2007. Pending further evaluation, completion operations will begin in the first quarter of 2008.

14. I hereby certify that the foregoing is true and correct.

Name (Printed/Typed)

Mary A. Maestas

Title Regulatory Assistant

Signature

Mary A. Maestas

Date 11/27/2007

THIS SPACE FOR FEDERAL OR STATE OFFICE USE

Approved by

Title

Date

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Office

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(Instructions on page 2)

RECEIVED

NOV 29 2007

DIV. OF OIL, GAS & MINING

UNITED STATES
DEPARTMENT OF THE INTERIOR
BUREAU OF LAND MANAGEMENT

FORM APPROVED
OMB No. 1004-0137
Expires: July 31, 2010

SUNDRY NOTICES AND REPORTS ON WELLS
**Do not use this form for proposals to drill or to re-enter an
abandoned well. Use Form 3160-3 (APD) for such proposals.**

5. Lease Serial No.
U-61400

6. If Indian, Allottee or Tribe Name

SUBMIT IN TRIPLICATE – Other instructions on page 2.

1. Type of Well

☐ Oil Well ☒ Gas Well ☐ Other

2. Name of Operator
EOG Resources, Inc.

3a. Address
600 17th Street, Suite 1000N
Denver, CO 80202

3b. Phone No. (include area code)
303-824-5526

4. Location of Well (Footage, Sec., T., R., M., or Survey Description)
2050' FSL & 480' FWL (NWSW) Lot 3
Sec. 30-T8S-R23E 40.082106 LAT 109.377192 LON

7. If Unit of CA/Agreement, Name and/or No.

8. Well Name and No.
Hoss 32-30

9. API Well No.
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<input checked="" type="checkbox"/> Subsequent Report	<input type="checkbox"/> Alter Casing	<input type="checkbox"/> Fracture Treat	<input type="checkbox"/> Reclamation	<input type="checkbox"/> Well Integrity
<input type="checkbox"/> Final Abandonment Notice	<input type="checkbox"/> Casing Repair	<input type="checkbox"/> New Construction	<input type="checkbox"/> Recomplete	<input checked="" type="checkbox"/> Other <u>Drilling operations</u>
	<input type="checkbox"/> Change Plans	<input type="checkbox"/> Plug and Abandon	<input type="checkbox"/> Temporarily Abandon	
	<input type="checkbox"/> Convert to Injection	<input type="checkbox"/> Plug Back	<input type="checkbox"/> Water Disposal	

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No completion work has been performed on the subject well. Pending further evaluation, completion operations will begin in the first quarter of 2008.

14. I hereby certify that the foregoing is true and correct.

Name (Printed/Typed)

Mary A. Maestas

Title Regulatory Assistant

Signature

Mary A. Maestas

Date 02/11/2008

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Approved by

Title

Date

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(Instructions on page 2)

RECEIVED

FEB 13 2008

DIV. OF OIL, GAS & MINING

NOTICE

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 - Form 8, Well Completion or Recompletion Report and Log
 - A copy of electric and radioactivity logs, if run
 - A copy of drillstem test reports,
 - A copy of formation water analyses, porosity, permeability or fluid saturation determinations
 - A copy of core analyses, and lithologic logs or sample descriptions if compiled
 - A copy of directional, deviation, and/or measurement-while-drilling survey for each horizontal well

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As of the mailing of this notice, the division has not received the required reports for

Operator: EOG Resources, Inc

Today's Date: 02/14/2008

Well:

API Number:

Drilling Commenced:

See Attachment

43 047 38701
HOSS 32-30
8S 23E 30

To avoid compliance action, required reports should be mailed within 7 business days to:

Utah Division of Oil, Gas and Mining
1594 West North Temple, Suite 1210
P.O. Box 145801
Salt Lake City, Utah 84114-5801

If you have questions or concerns regarding this matter, please call (801) 538-5284.

cc: Well File
Compliance File

Well:		API Number:	Commenced:
Pete's Wash 10-36	drlg rpts/wcr	4301333094	10/18/2006
Hoss 8-31	wcr	4304738606	11/30/2006
Simoleon 1-26GR	drlg rpts/wcr	4304737507	02/23/2007
Hoss 7-31	drlg rpts/wcr	4304738669	02/23/2007
E Chapita 8-16	drlg rpts/wcr	4304736815	03/17/2007
Hoss 1-36	drlg rpts/wcr	4304738612	03/22/2007
Hoss 11-31	drlg rpts/wcr	4304738670	03/24/2007
Hoss 35-30	drlg rpts/wcr	4304738706	03/24/2007
Hoss 36-30	drlg rpts/wcr	4304738763	03/24/2007
Hoss 21-32	drlg rpts/wcr	4304738714	04/09/2007
Hoss 20-32	drlg rpts/wcr	4304738717	04/17/2007
Hoss 23-32	drlg rpts/wcr	4304738716	04/25/2007
Hoss 4-36	drlg rpts/wcr	4304738609	05/03/2007
Hoss 32-30	drlg rpts/wcr	4304738701	06/12/2007
Hoss 37-30	drlg rpts/wcr	4304738709	06/12/2007
NBU 319-17E	drlg rpts/wcr	4304737511	07/05/2007
NBU 557-18E	drlg rpts/wcr	4304737513	07/07/2007
Hoss 38-30	drlg rpts/wcr	4304738708	07/11/2007
CWU 1237-21	wcr	4304738078	07/27/2007
Hoss 58-35	drlg rpts/wcr	4304738888	08/03/2007
Hoss 31-30	drlg rpts/wcr	4304738702	08/10/2007
Hoss 63-31	drlg rpts/wcr	4304738960	08/10/2007
NBU 556-18E	drlg rpts/wcr	4304737514	08/13/2007
CWU 957-32	drlg rpts/wcr	4304736486	08/16/2007
NBU 555-18E	drlg rpts/wcr	4304737685	08/19/2007
Hoss 62-36	drlg rpts/wcr	4304738972	08/28/2007
NBU 438-19E	drlg rpts/wcr	4304737534	08/31/2007
N Chapita 284-6	drlg rpts/wcr	4304737716	09/05/2007
CWU 1031-32	drlg rpts/wcr	4304737720	09/10/2007
Hoss 64-36	drlg rpts/wcr	4304738964	09/13/2007
CWU 963-33	drlg rpts/wcr	4304738961	09/14/2007
NBU 565-30E	drlg rpts/wcr	4304737533	09/20/2007
CWU 1328-32	drlg rpts/wcr	4304739301	09/27/2007
N Chapita 339-34	drlg rpts/wcr	4304738061	10/04/2007
NBU 562-19E	drlg rpts/wcr	4304737536	10/08/2007
CWU 1112-27	drlg rpts/wcr	4304737384	10/09/2007

UNITED STATES
DEPARTMENT OF THE INTERIOR
BUREAU OF LAND MANAGEMENTFORM APPROVED
OMB No. 1004-0137
Expires: July 31, 2010

WELL COMPLETION OR RECOMPLETION REPORT AND LOG

1a. Type of Well <input type="checkbox"/> Oil Well <input checked="" type="checkbox"/> Gas Well <input type="checkbox"/> Dry <input type="checkbox"/> Other			5. Lease Serial No. UTU61400		
b. Type of Completion <input checked="" type="checkbox"/> New Well <input type="checkbox"/> Work Over <input type="checkbox"/> Deepen <input type="checkbox"/> Plug Back <input type="checkbox"/> Diff. Resvr. Other _____			6. If Indian, Allottee or Tribe Name		
2. Name of Operator EOG RESOURCES, INC.			Contact: MARY A. MAESTAS E-Mail: mary_maestas@eogresources.com		
3. Address 600 17TH STREET SUITE 1000N DENVER, CO 80202			3a. Phone No. (include area code) Ph: 303-824-5526		
4. Location of Well (Report location clearly and in accordance with Federal requirements)* At surface Lot 3 2050FSL 480FWL 40.08211 N Lat, 109.37719 W Lon At top prod interval reported below Lot 3 2050FSL 480FWL 40.08211 N Lat, 109.37719 W Lon At total depth Lot 3 2050FSL 480FWL 40.08211 N Lat, 109.37719 W Lon			9. API Well No. 43-047-38701		
14. Date Spudded 06/12/2007			15. Date T.D. Reached 11/15/2007		
16. Date Completed <input type="checkbox"/> D & A <input checked="" type="checkbox"/> Ready to Prod. 02/14/2008			17. Elevations (DF, KB, RT, GL)* 4886 GL		
18. Total Depth: MD 10120 TVD			19. Plug Back T.D.: MD 10069 TVD		
20. Depth Bridge Plug Set: MD 9550 TVD			10. Field and Pool, or Exploratory NATURAL BUTTES/WASATCH/MV		
21. Type Electric & Other Mechanical Logs Run (Submit copy of each) RST/CBL/CCL/VDL/GR			11. Sec., T., R., M., or Block and Survey or Area Sec 30 T8S R23E Mer SLB		
22. Was well cored? <input checked="" type="checkbox"/> No <input type="checkbox"/> Yes (Submit analysis) Was DST run? <input checked="" type="checkbox"/> No <input type="checkbox"/> Yes (Submit analysis) Directional Survey? <input checked="" type="checkbox"/> No <input type="checkbox"/> Yes (Submit analysis)			12. County or Parish UINTAH		
23. Casing and Liner Record (Report all strings set in well)			13. State UT		

Hole Size	Size/Grade	Wt. (#/ft.)	Top (MD)	Bottom (MD)	Stage Cementer Depth	No. of Sks. & Type of Cement	Slurry Vol. (BBL)	Cement Top*	Amount Pulled
12.250	9.625 J-55	36.0	0	2747		725			
7.875	4.500 P-110	11.6	0	10112		2175			

Size	Depth Set (MD)	Packer Depth (MD)	Size	Depth Set (MD)	Packer Depth (MD)	Size	Depth Set (MD)	Packer Depth (MD)
2.375	8441							

Formation	Top	Bottom	Perforated Interval	Size	No. Holes	Perf. Status
AWASATCH/MESAVERDE	5781	9862	9719 TO 9862		3	
B)			9505 TO 9671		3	
C)			9292 TO 9465		3	
D)			9045 TO 9223		3	

Depth Interval	Amount and Type of Material
9719 TO 9862	91,909 GALS GELLED WATER & 152,400# 20/40 SAND
9505 TO 9671	43,302 GALS GELLED WATER & 85,300# 20/40 SAND
9292 TO 9465	45,441 GALS GELLED WATER & 109,000# 20/40 SAND
9045 TO 9223	82,477 GALS GELLED WATER & 406,400# 20/40 SAND

Date First Produced	Test Date	Hours Tested	Test Production	Oil BBL	Gas MCF	Water BBL	Oil Gravity Corr. API	Gas Gravity	Production Method
02/14/2008	02/23/2008	24	→	15.0	347.0	420.0			FLows FROM WELL
Choke Size	Tbg. Press. Flwg. SI	Csg. Press.	24 Hr. Rate	Oil BBL	Gas MCF	Water BBL	Gas:Oil Ratio	Well Status	
14/64"	1200	2225.0	→	15	347	420		PGW	

Date First Produced	Test Date	Hours Tested	Test Production	Oil BBL	Gas MCF	Water BBL	Oil Gravity Corr. API	Gas Gravity	Production Method
			→						
Choke Size	Tbg. Press. Flwg. SI	Csg. Press.	24 Hr. Rate	Oil BBL	Gas MCF	Water BBL	Gas:Oil Ratio	Well Status	
			→						

(See Instructions and spaces for additional data on reverse side)

ELECTRONIC SUBMISSION #59077 VERIFIED BY THE BLM WELL INFORMATION SYSTEM

** OPERATOR-SUBMITTED ** OPERATOR-SUBMITTED ** OPERATOR-SUBMITTED

RECEIVED

MAR 13 2008

28b. Production - Interval C

Date First Produced	Test Date	Hours Tested	Test Production	Oil BBL	Gas MCF	Water BBL	Oil Gravity Corr. API	Gas Gravity	Production Method
			→						
Choke Size	Tbg. Press. Flwg. SI	Csg. Press.	24 Hr. Rate	Oil BBL	Gas MCF	Water BBL	Gas:Oil Ratio	Well Status	
			→						

28c. Production - Interval D

Date First Produced	Test Date	Hours Tested	Test Production	Oil BBL	Gas MCF	Water BBL	Oil Gravity Corr. API	Gas Gravity	Production Method
			→						
Choke Size	Tbg. Press. Flwg. SI	Csg. Press.	24 Hr. Rate	Oil BBL	Gas MCF	Water BBL	Gas:Oil Ratio	Well Status	
			→						

29. Disposition of Gas(Sold, used for fuel, vented, etc.)
SOLD

30. Summary of Porous Zones (Include Aquifers):

Show all important zones of porosity and contents thereof: Cored intervals and all drill-stem tests, including depth interval tested, cushion used, time tool open, flowing and shut-in pressures and recoveries.

31. Formation (Log) Markers

Formation	Top	Bottom	Descriptions, Contents, etc.	Name	Top
					Meas. Depth
WASATCH/MESAVERDE	5781	9862		GREEN RIVER	2271
				MAHOGANY	2903
				WASATCH	5244
				CHAPITA WELLS	5847
				BUCK CANYON	6513
				PRICE RIVER	7736
				MIDDLE PRICE RIVER	8522
				LOWER PRICE RIVER	9390

32. Additional remarks (include plugging procedure):

Please see the attached sheet for detailed perforation and additional formation marker information.

33. Circle enclosed attachments:


- | | | | |
|---|--------------------|---------------|-----------------------|
| 1. Electrical/Mechanical Logs (1 full set req'd.) | 2. Geologic Report | 3. DST Report | 4. Directional Survey |
| 5. Sundry Notice for plugging and cement verification | 6. Core Analysis | 7. Other: | |

34. I hereby certify that the foregoing and attached information is complete and correct as determined from all available records (see attached instructions):

Electronic Submission #59077 Verified by the BLM Well Information System.
For EOG RESOURCES, INC., sent to the Vernal

Name (please print) MARY A. MAESTASTitle REGULATORY ASSISTANT

Signature

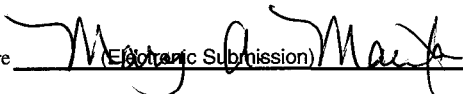

(Electronic Submission)

Date 03/12/2008

Title 18 U.S.C. Section 1001 and Title 43 U.S.C. Section 1212, make it a crime for any person knowingly and willfully to make to any department or agency of the United States any false, fictitious or fraudulent statements or representations as to any matter within its jurisdiction.

** ORIGINAL ** ORIGINAL ** ORIGINAL ** ORIGINAL ** ORIGINAL ** ORIGINAL ** ORIGINAL **

Hoss 32-30 - ADDITIONAL REMARKS (CONTINUED):

26. PERFORATION RECORD

8823-8941	3/spf
8699-8783	3/spf
8501-8628	3/spf
8185-8399	3/spf
7902-8137	3/spf
7578-7796	3/spf
7339-7471	3/spf
6940-7257	3/spf
6598-6838	3/spf
6119-6190	3/spf
5999-6066	3/spf
5922-5962	3/spf
5781-5829	3/spf

27. ACID, FRACTURE TREATMENT, CEMENT SQUEEZE, ETC.

8823-8941	43,433 GALS GELLED WATER & 106,900# 20/40 SAND
8699-8783	34,403 GALS GELLED WATER & 81,100# 20/40 SAND
8501-8628	56,537 GALS GELLED WATER & 146,800# 20/40 SAND
8185-8399	43,341 GALS GELLED WATER & 106,100# 20/40 SAND
7902-8137	43,110 GALS GELLED WATER & 108,000# 20/40 SAND
7578-7796	49,998 GALS GELLED WATER & 128,500# 20/40 SAND
7339-7471	29,845 GALS GELLED WATER & 50,100# 20/40 SAND
6940-7257	33,727 GALS GELLED WATER & 80,200# 20/40 SAND
6598-6838	37,185 GALS GELLED WATER & 88,200# 20/40 SAND
6119-6190	21,095 GALS GELLED WATER & 48,100# 20/40 SAND
5999-6066	20,858 GALS GELLED WATER & 47,800# 20/40 SAND
5922-5962	24,688 GALS GELLED WATER & 59,300# 20/40 SAND
5781-5829	34,121 GALS GELLED WATER & 82,460# 20/40 SAND

Perforated the Lower Price River from 9719-20', 9725-26', 9739-40', 9758-59', 9776-77', 9792-93', 9811-12', 9821-22', 9828-29', 9853-54', 9857-58' & 9861-62' w/ 3 spf.

Perforated the Lower Price River from 9505-07', 9513-14', 9523-24', 9569-70', 9594-95', 9607-08', 9611-12', 9651-53', 9665-66' & 9670-71' w/ 3 spf.

Perforated the Lower/Middle Price River from 9292-93', 9295-96', 9318-19', 9323-24', 9384-86', 9399-9400', 9405-06', 9420-21', 9453-54' & 9464-65' w/ 3 spf.

Perforated the Middle Price River from 9045-46', 9055-56', 9080-81', 9088-89', 9102-03', 9135-36', 9152-53', 9160-61', 9178-79', 9189-90', 9207-08' & 9222-23' w/ 3 spf.

Perforated the Middle/Upper Price River from 8823-24', 8833-34', 8840-41', 8849-50', 8856-57', 8881-82', 8892-93', 8905-06', 8919-20', 8932-33', 8936-37' & 8940-41' w/ 3 spf.

Perforated the Middle Price River from 8699-8700', 8703-04', 8709-10', 8719-20', 8726-27', 8732-33', 8737-39', 8750-51', 8768-70' & 8782-83' w/ 3 spf.

Perforated the Middle Price River from 8501-02', 8505-06', 8531-32', 8537-38', 8550-51', 8557-58', 8567-68', 8575-76', 8591-92', 8597-98', 8621-22' & 8627-28' w/ 3 spf.

Perforated the Upper Price River from 8195-96', 8219-20', 8225-26', 8237-38', 8245-46', 8266-67', 8284-85', 8288-89', 8382-84', 8389-90' & 8398-99' w/ 3 spf.

Perforated the Upper Price River from 7902-03', 7920-21', 7935-36', 7958-59', 7978-79', 8023-24', 8052-53', 8091-92', 8101-02', 8115-16', 8120-21' & 8136-37' w/ 3 spf.

Perforated the North Horn/Upper Price River from 7578-79', 7587-88', 7620-21', 7635-36', 7643-44', 7650-51', 7690-91', 7696-97', 7735-36', 7779-80', 7791-92' & 7795-96' w/ 3 spf.

Perforated the North Horn from 7339-40', 7362-63', 7382-83', 7390-91', 7403-04', 7424-25', 7438-39', 7442-43', 7461-62', 7465-66' w/ 7470-71' w/ 3 spf.

Perforated the Ba/North Horn from 6940-41', 6969-70', 7025-26', 7057-58', 7104-05', 7170-71', 7174-75', 7186-87', 7199-7200', 7223-24', 7233-34' & 7256-57' w/ 3 spf.

Perforated the Ba from 6598-99', 6601-02', 6607-08', 6622-23', 6645-46', 6680-81', 6683-84', 6741-42', 6754-55', 6790-91', 6812-13' & 6837-38' w/ 3 spf.

Perforated the Ca from 6119-20', 6138-39', 6151-52', 6161-62' & 6182-90' w/ 3 spf.

Perforated the Ca from 5999-6002', 6010-11', 6014-15', 6018-19', 6045-48', 6053-54' & 6055-56' w/ 3 spf.

Perforated the Ca from 5922-24', 5946-47' & 5953-62' w/ 3 spf.

Perforated the Pp from 5781-83', 5804-08', 5817-21' & 5827-29' w/ 3 spf.

52. FORMATION (LOG) MARKERS

SEGO	9943
------	------

STATE OF UTAH
DEPARTMENT OF NATURAL RESOURCES
DIVISION OF OIL, GAS AND MINING

FORM 7

REPORT OF WATER ENCOUNTERED DURING DRILLING

Well name and number: HOSS 32-30

API number: 4304738701

Well Location: QQ LOT3 Section 30 Township 8S Range 23E County UINTAH

Well operator: EOG

Address: 1060 E HWY 40

city VERNAL state UT zip 84078

Phone: (435) 781-9111

Drilling contractor: CRAIGS ROUSTABOUT SERVICE

Address: PO BOX 41

city JENSEN state UT zip 84035

Phone: (435) 781-1367

Water encountered (attach additional pages as needed):

DEPTH		VOLUME (FLOW RATE OR HEAD)	QUALITY (FRESH OR SALTY)
FROM	TO		
2,310	2,330	NO FLOW	NOT KNOWN

Formation tops:
(Top to Bottom)

1	2	3
4	5	6
7	8	9
10	11	12

If an analysis has been made of the water encountered, please attach a copy of the report to this form.

I hereby certify that this report is true and complete to the best of my knowledge.

NAME (PLEASE PRINT) Mary A. Maestas

TITLE Regulatory Assistant

SIGNATURE

Mary A. Maestas

DATE

3/12/2008

UNITED STATES
DEPARTMENT OF THE INTERIOR
BUREAU OF LAND MANAGEMENT

FORM APPROVED
OMB NO. 1004-0135
Expires: July 31, 2010

SUNDRY NOTICES AND REPORTS ON WELLS
Do not use this form for proposals to drill or to re-enter an abandoned well. Use form 3160-3 (APD) for such proposals.

SUBMIT IN TRIPLICATE - Other instructions on reverse side.

1. Type of Well <input type="checkbox"/> Oil Well <input checked="" type="checkbox"/> Gas Well <input type="checkbox"/> Other		5. Lease Serial No. UTU61400
2. Name of Operator EOG RESOURCES INC		6. If Indian, Allottee or Tribe Name
Contact: MARY A. MAESTAS E-Mail: mary_maestas@eogresources.com		7. If Unit or CA/Agreement, Name and/or No.
3a. Address 600 17TH STREET SUITE 1000N DENVER, CO 80202	3b. Phone No. (include area code) Ph: 303-824-5526	8. Well Name and No. HOSS 32-30
4. Location of Well (Footage, Sec., T., R., M., or Survey Description) Sec 30 T8S R23E NWSW 2050FSL 480FWL 40.08211 N Lat, 109.37719 W Lon		9. API Well No. 43-047-38701
		10. Field and Pool, or Exploratory NATURAL BUTTES/WASATCH/MV
		11. County or Parish, and State UINTAH COUNTY, UT


12. CHECK APPROPRIATE BOX(ES) TO INDICATE NATURE OF NOTICE, REPORT, OR OTHER DATA

TYPE OF SUBMISSION	TYPE OF ACTION			
<input checked="" type="checkbox"/> Notice of Intent	<input type="checkbox"/> Acidize	<input type="checkbox"/> Deepen	<input type="checkbox"/> Production (Start/Resume)	<input type="checkbox"/> Water Shut-Off
<input type="checkbox"/> Subsequent Report	<input type="checkbox"/> Alter Casing	<input type="checkbox"/> Fracture Treat	<input type="checkbox"/> Reclamation	<input type="checkbox"/> Well Integrity
<input type="checkbox"/> Final Abandonment Notice	<input type="checkbox"/> Casing Repair	<input type="checkbox"/> New Construction	<input type="checkbox"/> Recomplete	<input checked="" type="checkbox"/> Other
	<input type="checkbox"/> Change Plans	<input type="checkbox"/> Plug and Abandon	<input type="checkbox"/> Temporarily Abandon	
	<input type="checkbox"/> Convert to Injection	<input type="checkbox"/> Plug Back	<input type="checkbox"/> Water Disposal	

13. Describe Proposed or Completed Operation (clearly state all pertinent details, including estimated starting date of any proposed work and approximate duration thereof. If the proposal is to deepen directionally or recompleat horizontally, give subsurface locations and measured and true vertical depths of all pertinent markers and zones. Attach the Bond under which the work will be performed or provide the Bond No. on file with BLM/BIA. Required subsequent reports shall be filed within 30 days following completion of the involved operations. If the operation results in a multiple completion or recompletion in a new interval, a Form 3160-4 shall be filed once testing has been completed. Final Abandonment Notices shall be filed only after all requirements, including reclamation, have been completed, and the operator has determined that the site is ready for final inspection.)

EOG Resources, Inc. requests authorization to use a low-profile evaporation unit in the reserve pit for the referenced location.

**Accepted by the
Utah Division of
Oil, Gas and Mining
FOR RECORD ONLY**

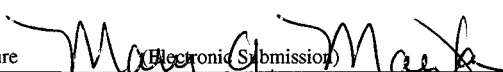14. I hereby certify that the foregoing is true and correct. Electronic Submission #60627 verified by the BLM Well Information System For EOG RESOURCES INC, sent to the Vernal	
Name (Printed/Typed) MARY A. MAESTAS	Title REGULATORY ASSISTANT
Signature  (Electronic Submission)	Date 06/04/2008

THIS SPACE FOR FEDERAL OR STATE OFFICE USE

Approved By _____	Title _____	Date _____
Conditions of approval, if any, are attached. Approval of this notice does not warrant or certify that the applicant holds legal or equitable title to those rights in the subject lease which would entitle the applicant to conduct operations thereon.		Office _____

Title 18 U.S.C. Section 1001 and Title 43 U.S.C. Section 1212, make it a crime for any person knowingly and willfully to make to any department or agency of the United States any false, fictitious or fraudulent statements or representations as to any matter within its jurisdiction.

**** OPERATOR-SUBMITTED ** OPERATOR-SUBMITTED ** OPERATOR-SUBMITTED ****

RECEIVED
JUN 06 2008

DIV. OF OIL, GAS & MINING

UNITED STATES
DEPARTMENT OF THE INTERIOR
BUREAU OF LAND MANAGEMENT

FORM APPROVED
OMB NO. 1004-0135
Expires: July 31, 2010

SUNDRY NOTICES AND REPORTS ON WELLS
Do not use this form for proposals to drill or to re-enter an abandoned well. Use form 3160-3 (APD) for such proposals.

5. Lease Serial No.
UTU61400

6. If Indian, Allottee or Tribe Name

7. If Unit or CA/Agreement, Name and/or No.

8. Well Name and No.
HOSS 32-30

9. API Well No.
43-047-38701

10. Field and Pool, or Exploratory
NATURAL BUTTES

11. County or Parish, and State
UINTAH COUNTY, UT

SUBMIT IN TRIPLICATE - Other instructions on reverse side.

1. Type of Well
☐ Oil Well ☒ Gas Well ☐ Other

2. Name of Operator
EOG RESOURCES, INC. Contact: MICKENZIE THACKER
E-Mail: MICKENZIE_THACKER@EOGRESOURCES.COM

3a. Address
1060 E. HWY 40
VERNAL, UT 84078

3b. Phone No. (include area code)
Ph: 453-781-9145

4. Location of Well (Footage, Sec., T., R., M., or Survey Description)
Sec 30 T8S R23E NWSW 2050FSL 480FWL
40.08211 N Lat, 109.37719 W Lon

12. CHECK APPROPRIATE BOX(ES) TO INDICATE NATURE OF NOTICE, REPORT, OR OTHER DATA

TYPE OF SUBMISSION	TYPE OF ACTION			
<input type="checkbox"/> Notice of Intent	<input type="checkbox"/> Acidize	<input type="checkbox"/> Deepen	<input type="checkbox"/> Production (Start/Resume)	<input type="checkbox"/> Water Shut-Off
<input checked="" type="checkbox"/> Subsequent Report	<input type="checkbox"/> Alter Casing	<input type="checkbox"/> Fracture Treat	<input checked="" type="checkbox"/> Reclamation	<input type="checkbox"/> Well Integrity
<input type="checkbox"/> Final Abandonment Notice	<input type="checkbox"/> Casing Repair	<input type="checkbox"/> New Construction	<input type="checkbox"/> Recomplete	<input type="checkbox"/> Other
	<input type="checkbox"/> Change Plans	<input type="checkbox"/> Plug and Abandon	<input type="checkbox"/> Temporarily Abandon	
	<input type="checkbox"/> Convert to Injection	<input type="checkbox"/> Plug Back	<input type="checkbox"/> Water Disposal	

13. Describe Proposed or Completed Operation (clearly state all pertinent details, including estimated starting date of any proposed work and approximate duration thereof. If the proposal is to deepen directionally or recompleat horizontally, give subsurface locations and measured and true vertical depths of all pertinent markers and zones. Attach the Bond under which the work will be performed or provide the Bond No. on file with BLM/BIA. Required subsequent reports shall be filed within 30 days following completion of the involved operations. If the operation results in a multiple completion or recompleat in a new interval, a Form 3160-4 shall be filed once testing has been completed. Final Abandonment Notices shall be filed only after all requirements, including reclamation, have been completed, and the operator has determined that the site is ready for final inspection.)

All material, debris, trash, and junk was removed from the location. The reserve pit was reclaimed. Stockpiled topsoil was spread over the pit area and broadcast seeded with the prescribed seed mixture. The seeded area was then walked down with a cat. Interim reclamation was completed on 9/29/2008.

14. I hereby certify that the foregoing is true and correct.

**Electronic Submission #66342 verified by the BLM Well Information System
For EOG RESOURCES, INC., sent to the Vernal**

Name (Printed/Typed) MICKENZIE THACKER

Title OPERATIONS CLERK

Signature

Mickenzie Thacker

Date 01/14/2009

THIS SPACE FOR FEDERAL OR STATE OFFICE USE

Approved By

Title

Date

Conditions of approval, if any, are attached. Approval of this notice does not warrant or certify that the applicant holds legal or equitable title to those rights in the subject lease which would entitle the applicant to conduct operations thereon.

Office

Title 18 U.S.C. Section 1001 and Title 43 U.S.C. Section 1212, make it a crime for any person knowingly and willfully to make to any department or agency of the United States any false, fictitious or fraudulent statements or representations as to any matter within its jurisdiction.

**** OPERATOR-SUBMITTED ** OPERATOR-SUBMITTED ** OPERATOR-SUBMITTED ****

RECEIVED

JAN 20 2009

DIV. OF OIL, GAS & MINING